



1 FIRST FLOOR DEMOLITION REFLECTED CEILING PLAN
 D21 1/4" = 1'-0" REFERENCE: A3.1

LEGEND - DEMOLITION PLAN

- EXISTING WALL TO BE DEMOLISHED
- EXISTING WALL TO REMAIN
- EXISTING DOOR TO BE DEMOLISHED
- EXISTING DOOR TO REMAIN

GENERAL NOTES - DEMOLITION PLAN

1. FIELD VERIFY EXISTING CONDITIONS PRIOR TO COMMENCEMENT OF DEMOLITION AND NEW WORK. EXISTING BUILDING INFORMATION SHOWN IS BASED ON THE EXISTING DRAWINGS PROVIDED BY THE OWNER. GENERAL CONTRACTOR AND SUB CONTRACTORS ARE TO FIELD VERIFY EXISTING CONDITIONS PRIOR TO BID AND PRIOR TO CONSTRUCTION/DEMOLITION.
2. PROVIDE AND INSTALL ALL SHORING AND SUPPORT SYSTEMS NECESSARY TO ENSURE EXISTING STRUCTURE TO REMAIN IS STABLE THROUGHOUT DEMOLITION AND NEW CONSTRUCTION.
3. ALL DEMOLITION REQUIRED FOR FUTURE INSTALLATION OF MECHANICAL CHASES AND PIPING TO BE COORDINATED WITH MECHANICAL DRAWINGS, EQUIPMENT SPECIFICATIONS, AND STRUCTURAL DRAWINGS.
4. CONTACT OWNER UPON DISCOVERY OF ANY SUSPECTED ASBESTOS-CONTAINING MATERIALS OR OTHER SUSPECTED HAZARDOUS MATERIALS NOT SHOWN TO BE REMOVED WITHIN THE PROJECT SCOPE.
5. REMOVE ALL EXISTING SPRINKLER PIPING, CONDUIT, MECHANICAL EQUIPMENT, ETC. FROM AREA OF WORK UNLESS NOTED TO REMAIN. CONTACT ARCHITECT IF ANY EXISTING MATERIALS TO BE DEMOLISHED ARE IN QUESTION. SEE MECHANICAL, ELECTRICAL, PLUMBING AND FIRE PROTECTION DRAWINGS FOR ADDITIONAL INFORMATION.
6. CONTRACTOR SHALL PHOTOGRAPH ALL SPACES PRIOR TO COMMENCEMENT OF RENOVATION/NEW WORK TO DOCUMENT PRE-CONSTRUCTION CONDITIONS. PROVIDE ARCHITECT WITH ELECTRONIC COPIES OF PHOTOGRAPHS.
7. CAREFULLY REMOVE ALL "MASONRY INFILL" WALL CONSTRUCTION AS INDICATED ON DEMOLITION PLANS AND ELEVATIONS. REVIEW CONCRETE OPENING CONDITIONS/DETAILS WITH ARCHITECT AND WINDOW AND DOOR SUPPLIER TO ENSURE THAT CONCRETE OPENINGS AND WINDOW INSTALLATION REQUIREMENTS ARE COORDINATED.
8. PROTECT EXISTING FLOORING AND CEILING TO REMAIN THROUGHOUT DEMOLITION AND NEW CONSTRUCTION.
9. SEE ELECTRICAL, MECHANICAL, PLUMBING AND STRUCTURAL DRAWINGS FOR ADDITIONAL INFORMATION REGARDING THE AREAS OF THE EXISTING CONCRETE SLAB TO BE REMOVED.
10. SEE STRUCTURAL DRAWINGS FOR ADDITIONAL INFORMATION REGARDING EXISTING COLUMNS AND BEAMS. PROTECT ALL EXISTING WALLS, COLUMNS, AND STRUCTURE TO REMAIN.
11. INSTALL SELF-LEVELING FLOOR MATERIAL TO ALL FLOOR AREAS THAT ARE TO BE REMOVED OR TO BE FULFILLED WITH NEW SLABS TO ENSURE FLUSH, SMOOTH FINISH FLOOR PLANE CONDITIONS THROUGHOUT RENOVATED BUILDING.
12. CORE DRILLING IN EXISTING SLAB FOR NEW UTILITY SERVICE IS NOT SHOWN ON THIS PLAN. SEE MECHANICAL, PLUMBING, AND ELECTRICAL DRAWINGS FOR REQUIRED UTILITY ROUTING.
13. PROTECT ALL EXISTING WATERPROOFING THROUGHOUT DEMOLITION & NEW CONSTRUCTION. PHOTOGRAPH ANY OBTURED OR DAMAGED WATERPROOFING AREAS AND NOTIFY ARCHITECT OF CONDITIONS PRIOR TO INSTALLING NEW WORK OR BACKFILLING AREAS.
14. REPAIR BOTTOM OF ALL EXISTING COLUMNS AROUND BASE OR HEAD WHEN SURROUNDING SLAB IS REMOVED. SEE SPECIFICATIONS FOR APPLICABLE SURFACE PREPARATION AND PRODUCTS TO BE UTILIZED FOR PATCHING.

15. ITEMS TO BE SALVAGED AND REMOVED BY OWNER PRIOR TO DEMOLITION ARE IDENTIFIED WITHIN THE SPECIFICATIONS.
16. ALL CEILING AND SOFFIT CONSTRUCTION INCLUDING ELECTRICAL, MECHANICAL, FIRE PROTECTION, ETC. LOCATED WITHIN AND ABOVE CEILING CONSTRUCTION TO BE REMOVED IN THEIR ENTIRETY UNLESS NOTED OTHERWISE.
17. HAZARDOUS MATERIALS ARE PRESENT IN THE SCOPE OF DEMOLITION/CONSTRUCTION. A REPORT ON THE PRESENCE OF HAZARDOUS MATERIALS IS ON FILE FOR REVIEW. HAZARDOUS MATERIALS SHALL BE REMOVED BY OWNER AND A SCHEDULE FOR THE REMOVAL SHALL BE COORDINATED WITH OWNER AND ARCHITECT.

KEYNOTES - DEMOLITION RCP

- 1 DEMO EXISTING CEILING GRID AND TILES. REMOVE LIGHTING FIXTURES
- 2 REMOVE EXISTING LIGHT - SEE ELEC. FIELD VERIFY LOCATION AND QUANTITY OF LIGHTS TO BE REMOVED.
- 3 REMOVE EXISTING LAY-IN SOFFIT.
- 4 REMOVE EXISTING CEILING AND ALL ASSOCIATED FIXTURES - SEE ELEC., MECH., AND PLUMB. DWGS.
- 5 EXISTING PLASTER CEILING, FIXTURES, AND VENTS TO REMAIN.
- 6 REMOVE, PROTECT AND REINSTALL EXISTING CEILING AS REQUIRED FOR MECHANICAL INSTALLATION. SEE MECHANICAL. GC TO REPLACE/ATCH ANY DAMAGED GRID/CEILING TILE DAMAGED DURING SCOPE OF WORK.
- 7 REMOVE, PROTECT, AND REINSTALL EXISTING METAL GRID CEILING AS REQUIRED FOR MECHANICAL INSTALLATION. SEE MECHANICAL. GC TO REPLACE ANY METAL GRID DAMAGED DURING SCOPE OF WORK.
- 8 EXISTING CEILING TO REMAIN. PROTECT THROUGHOUT DEMOLITION/CONSTRUCTION.

NO.	REVISIONS	DATE

PROJECT TITLE
SWIM TEAM LOCKER ROOM RENOVATIONS
 University of South Carolina
 Solomon Blatt Physical Education Center
 1300 Wheat Street
 Columbia, SC 29208 USC
 Project No. H27-Z158


NO.	REVISIONS	DATE

DRAWN BY: [Blank]
CHECKED BY: [Blank]
THIS DRAWING IS THE PROPERTY OF GARVIN DESIGN GROUP. IT IS TO BE USED ONLY FOR THE PROJECT AND SITE SPECIFICALLY IDENTIFIED HEREON. IT IS NOT TO BE REPRODUCED, COPIED, OR IN ANY MANNER USED FOR ANY OTHER PROJECT WITHOUT THE WRITTEN PERMISSION OF GARVIN DESIGN GROUP, INC. ©2011 GARVIN DESIGN GROUP, INC.


DRAWING TITLE
FIRST FLOOR DEMOLITION REFLECTED CEILING PLAN

PROJECT NO. U028.13
DATE 04.30.14
DRAWING NO. **D2.1**

5/1/2014 3:47:17 PM

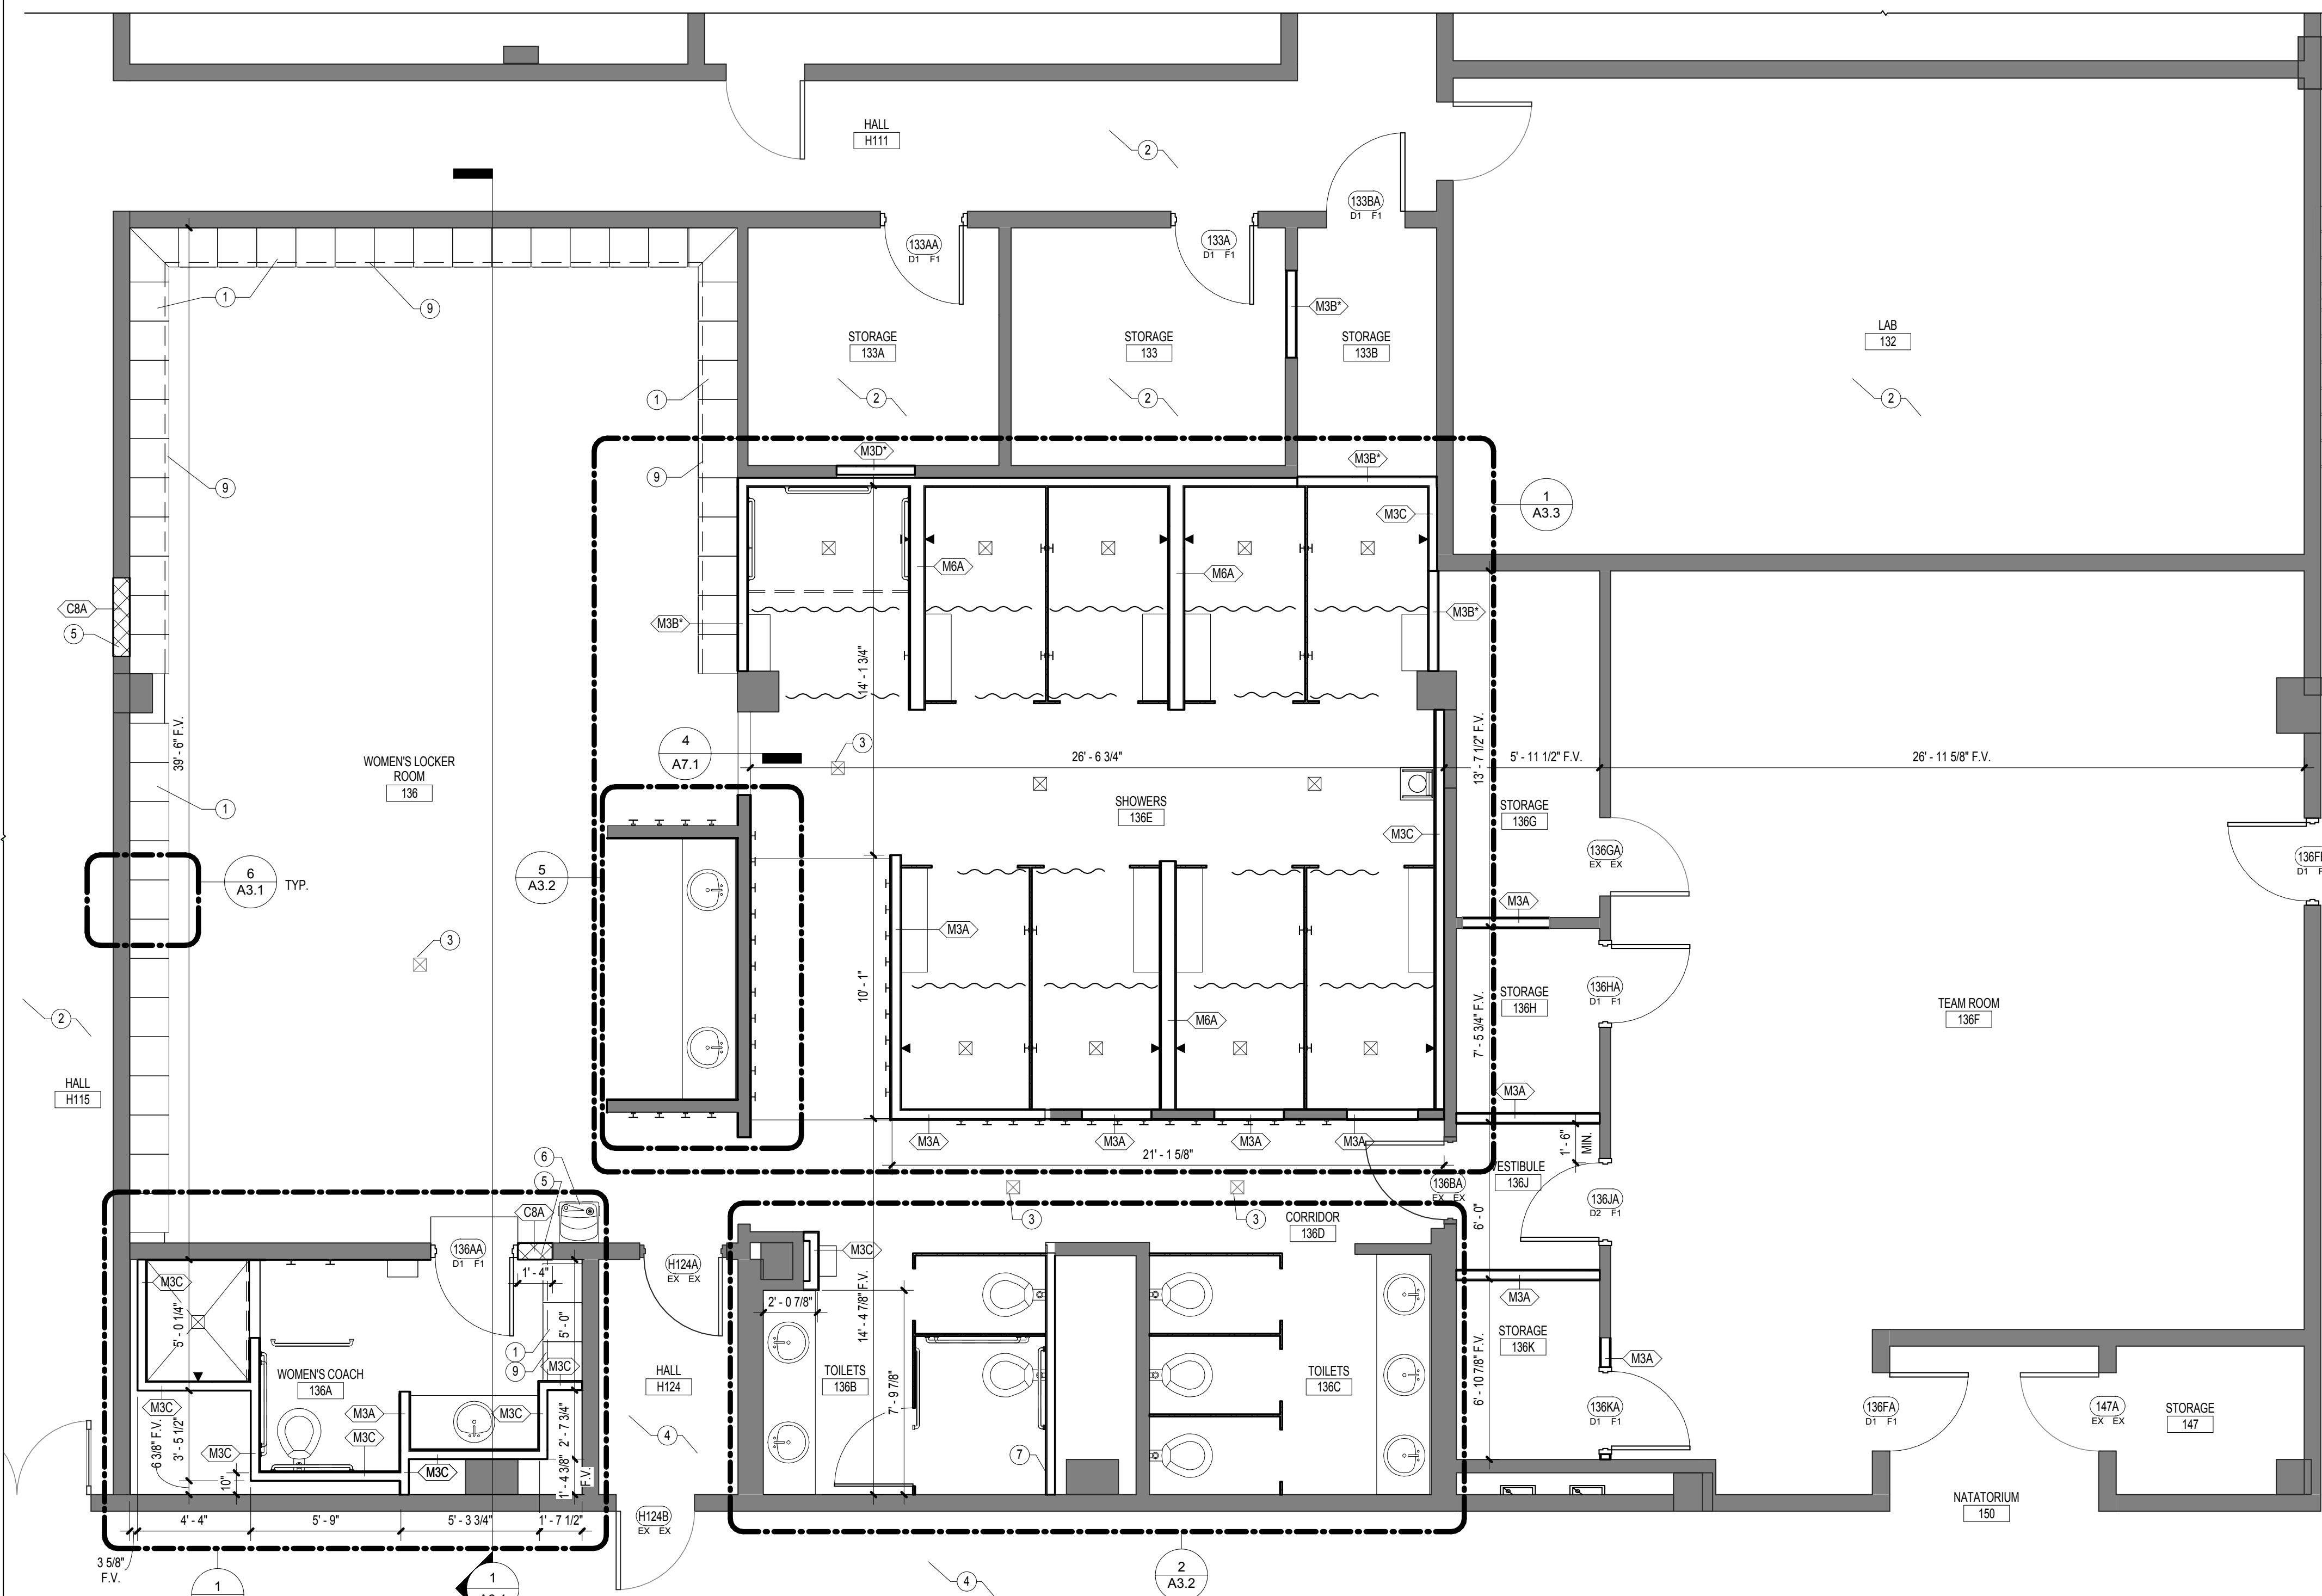

1 FIRST FLOOR PLAN
 A1.1 1/4" = 1'-0"
 REFERENCED: A3.1

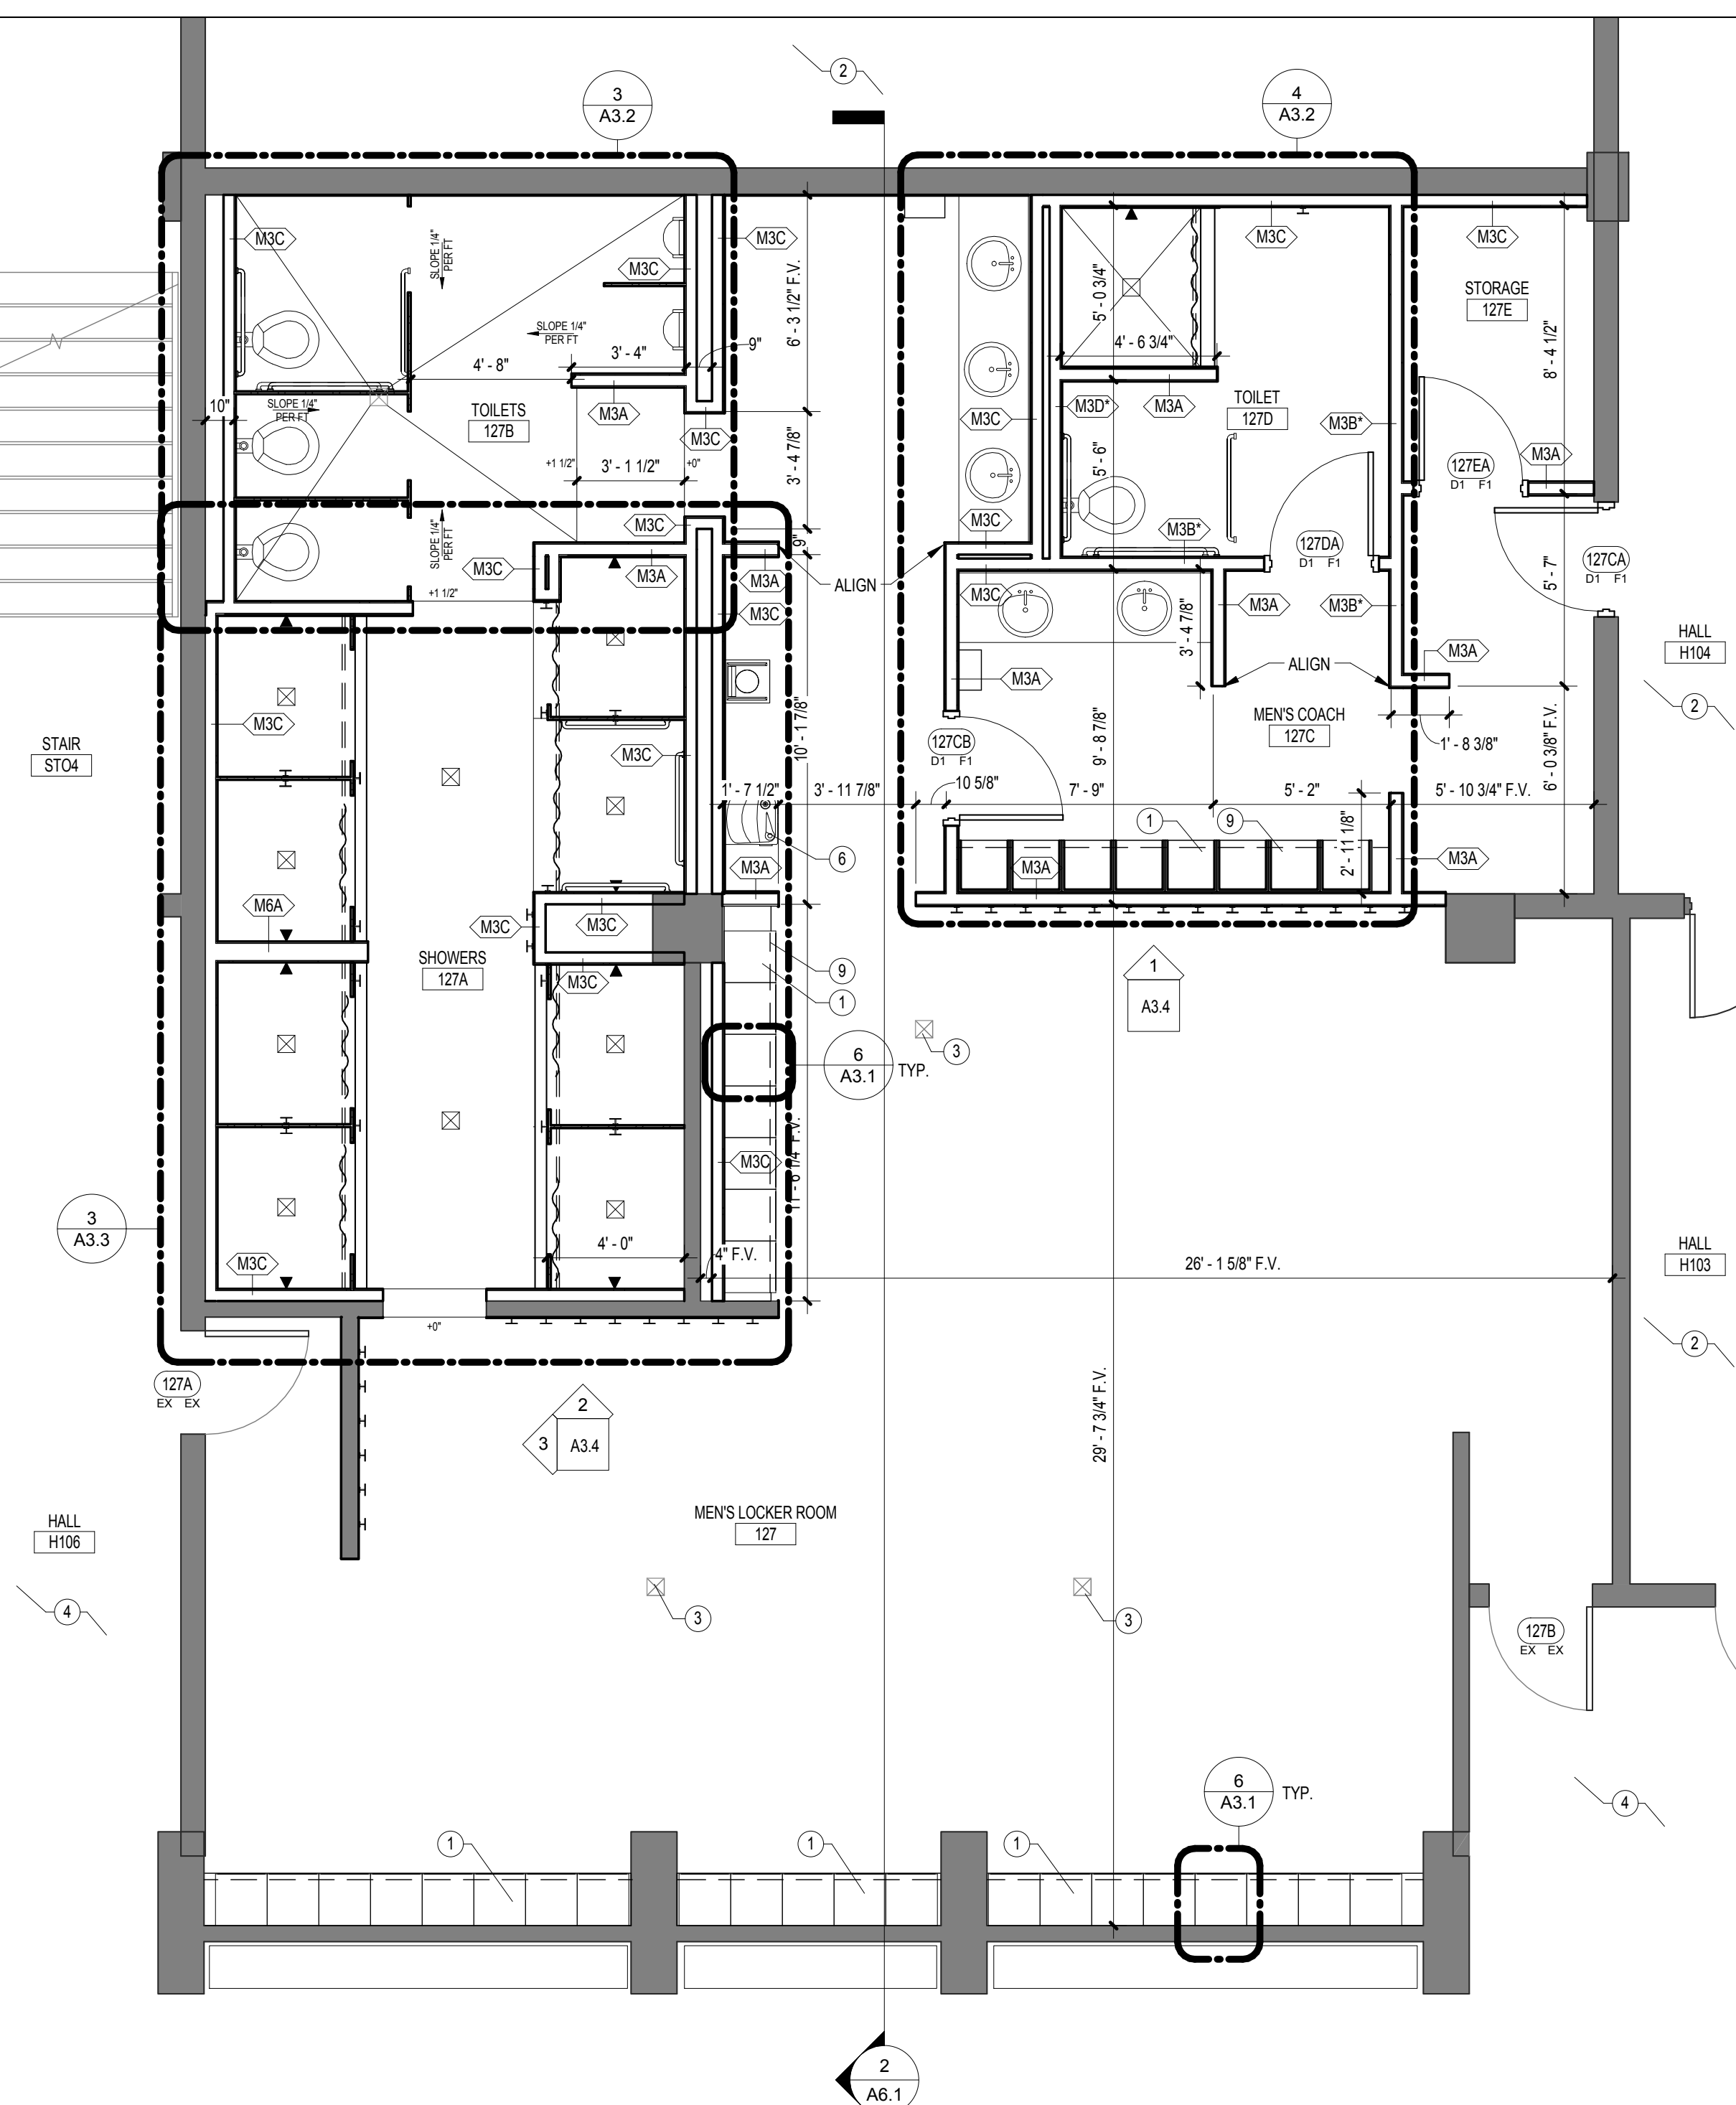

2 SECOND FLOOR PLAN
 A1.1 1/4" = 1'-0"
 REFERENCED: A2.1

LEGEND - REFLECTED CEILING PLAN


- ONE-HOUR FIRE-RATED WALL ASSEMBLY
 - - - TWO-HOUR FIRE-RATED WALL ASSEMBLY
 - FOUR-HOUR FIRE-RATED WALL ASSEMBLY
 - - - HALF-HOUR FIRE-RATED WALL ASSEMBLY
- SEE PARTITION TYPES FOR UL DESIGN NOS.
- FE-8 FIRE EXTINGUISHER MOUNTED ON WALL BRACKETS
 - ⊕ FD - FLOOR DRAIN
 - EXISTING WALL TO REMAIN

GENERAL NOTES - FLOOR PLAN

1. SEE T1.1 FOR MINIMUM REQUIRED ADA MANEUVERING CLEARANCES. VERIFY EXACT FE-8 AND FE-9 LOCATIONS WITH ARCHITECT - CENTER FECS ON VERTICAL MORTAR JOINTS IN EXPOSED CMU WALLS.
2. SEE T1.1 FOR REQUIRED UL ASSEMBLIES OF ALL BUILDING SYSTEMS. ALL PENETRATIONS THROUGH RATED WALL AND FLOOR ASSEMBLIES MUST COMPLY WITH UL DESIGN FOR PENETRATIONS.
3. DIMENSIONS INDICATED ON THESE DRAWINGS ARE TO FACE OF CMU WALL, FACE OF EXTERIOR VENEER, FACE OF STUD WALL OR CENTERLINE OF COLUMN UNLESS OTHERWISE INDICATED. DIMENSIONS INDICATED AT EXISTING WALLS ARE TO FACE OF FINISH SURFACE. COORDINATE ALL DIMENSIONS WITH STRUCTURAL, DIMENSION PLANS, ENLARGED PLANS, SECTION AND DETAIL DRAWINGS, AND STRUCTURAL DRAWINGS AND VERIFY EXACT LOCATIONS. COORDINATE ALL FLOOR SLAB PENETRATIONS WITH SYSTEM DRAWINGS (S.S., M.S., P.S. AND E.S.) AND ACTUAL PRODUCT TO BE INSTALLED AND VERIFY LOCATIONS WITH ARCHITECTURAL DRAWINGS PRIOR TO INSTALLATION.
4. SEE FINISH SCHEDULES AND PLANS FOR FLOOR PATTERNS AND FLOOR FINISH REFERENCES.
5. INTERIOR METAL STUD OPENINGS TO RECEIVE STOREFRONT, DOORS, GRILLS, LOUVERS, OR OTHER ELEMENTS SHALL BE FIELD VERIFIED PRIOR TO MANUFACTURE OF SYSTEM. LOCATION OF ALL RECESSED CABINETS AND EQUIPMENT WALL PENETRATIONS MUST BE VERIFIED PRIOR TO INSTALLATION OF CMU WALLS TO ENSURE INDICATED LOCATION AND EVEN COURSING. ANY CONFLICTS WITH INDICATED DIMENSIONS OR LOCATIONS SHALL BE COORDINATED WITH ARCHITECT PRIOR TO INSTALLATION.
6. ALL EXISTING COLUMNS ARE TO REMAIN.
7. PATCH ALL EXISTING HOLES IN CONCRETE STRUCTURE TO REMAIN, SEE SPECIFICATIONS FOR ADDITIONAL INFORMATION.
8. HAZARDOUS MATERIALS ARE PRESENT IN THE SCOPE OF DEMOLITION/CONSTRUCTION. A REPORT ON THE PRESENCE OF HAZARDOUS MATERIALS IS ON FILE FOR REVIEW. HAZARDOUS MATERIALS SHALL BE REMOVED BY OWNER PRIOR TO THE START OF DEMOLITION/CONSTRUCTION.
9. CONTACT OWNER UPON DISCOVERY OF ANY SUSPECTED ASBESTOS-CONTAINING MATERIALS OR OTHER SUSPECTED HAZARDOUS MATERIALS NOT SHOWN TO BE REMOVED WITHIN THE PROJECT SCOPE.
10. SEE PLUMBING DWGS. FOR LOCATIONS AND DETAILS OF REINSTALLED PLUMBING FIXTURES.

KEYNOTES - FLOOR PLAN


- 1 NEW PHENOLIC LOCKERS - SEE DETAILS AND SPECS PROVIDE FILLER PANELS AT ENDS OF RUNS AND CORNERS AS REQUIRED.
- 2 EXISTING FLOORING TO REMAIN. PROTECT THROUGHOUT DEMOLITION AND CONSTRUCTION.
- 3 EXISTING FLOOR DRAIN TO REMAIN.
- 4 EXISTING TILE POOL DECK TO REMAIN. PROTECT THROUGHOUT DEMOLITION/CONSTRUCTION. CONTRACTOR TO COVER AREA AFFECTED BY PROJECT SCOPE WITH PLYWOOD FOR DURATION OF WORK.
- 5 VERIFY EXISTING WALL WIDTH IN FIELD AND MATCH NEW INFILL WALL WIDTH WITH EXISTING.
- 6 NEW DRINKING FOUNTAIN, SEE PLUMBING.
- 7 INSTALL NEW WALL REMOVED FOR INSTALLATION/REINSTALLATION OF PLUMBING FIXTURES, SEE PLUMBING.
- 8 NEW CONCRETE CURB. SEE DETAILS AND SPECIFICATIONS.
- 9 NEW CONCRETE LOCKER BASE TO MATCH EXISTING.

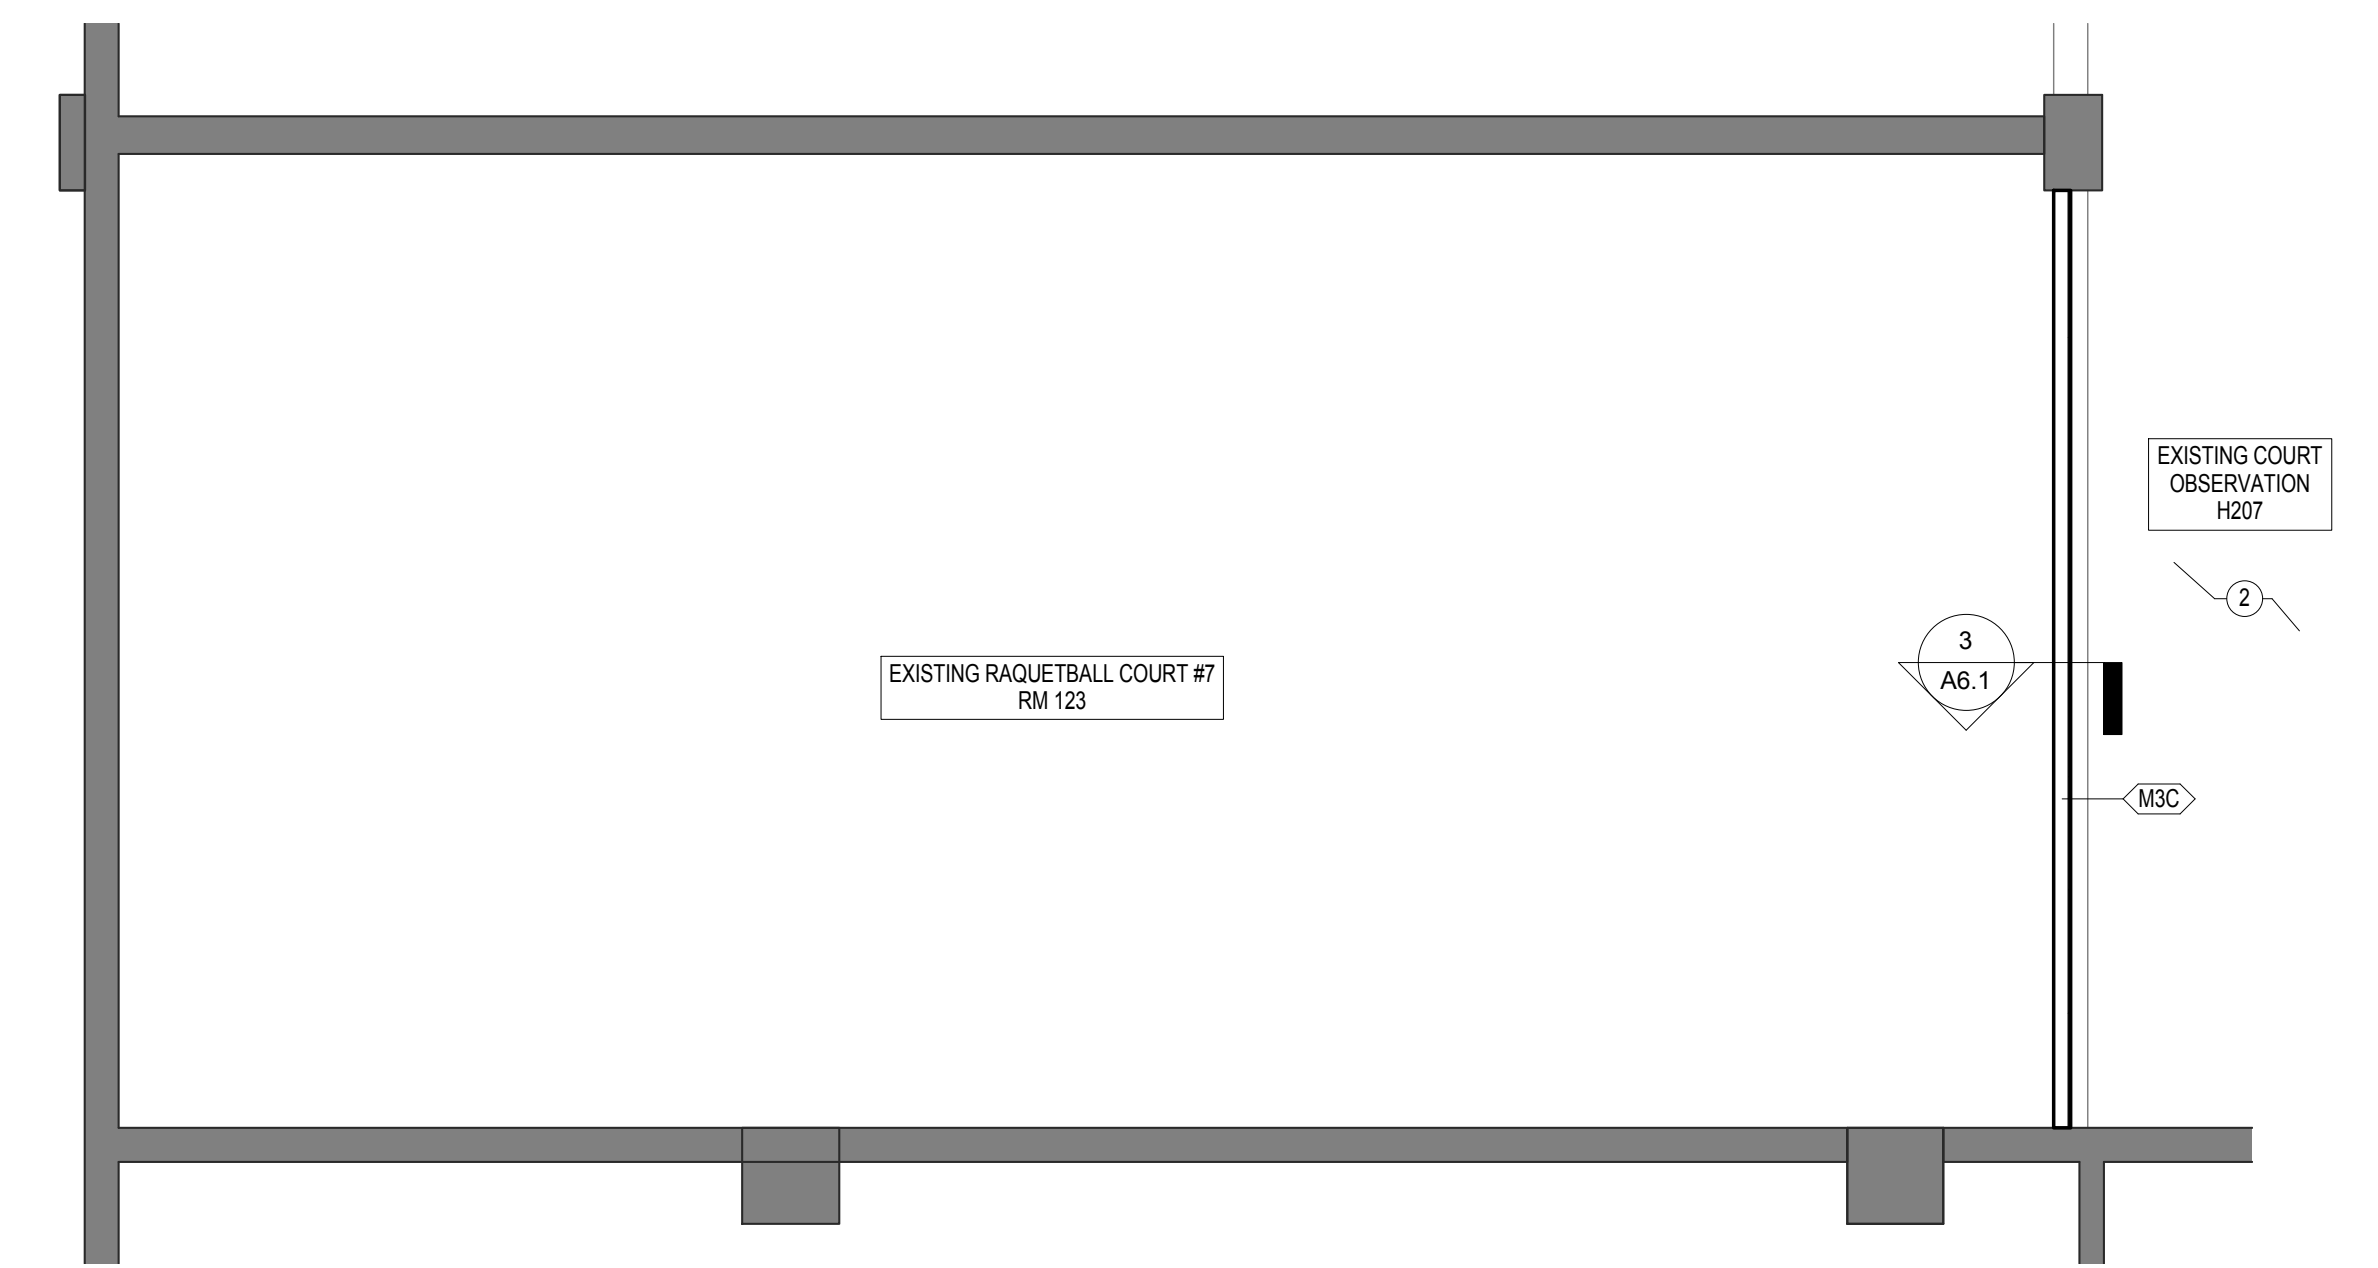

NO.	REVISIONS	DATE

DRAWN BY:	AUT/2	CHECKED BY:	CH/2
-----------	-------	-------------	------

DOOR SCHEDULE										
MARK	WIDTH	HEIGHT	DOOR TYPE	FRAME TYPE	HEAD	JAMB	SILL	RATING	HDWR	REMARKS
127A	3'-0"	7'-0"	EX	EX						
127B	3'-0"	7'-0"	EX	EX						
127CA	3'-0"	7'-0"	D1	F1	H1	J1				
127CB	3'-0"	7'-0"	D1	F1	H3	J2				
127DA	3'-0"	7'-0"	D1	F1	H3	J2				
127EA	3'-0"	7'-0"	D1	F1	H3	J2				
133A	3'-0"	7'-0"	D1	F1	H2	J1				
133AA	3'-0"	7'-0"	D1	F1	H2	J1				
133BA	3'-0"	7'-0"	D1	F1	H1	J1				
136AA	3'-0"	6'-8"	D1	F1	H2	J1				
136BA	3'-0"	7'-0"	EX	EX						
136FA	3'-0"	7'-0"	D1	F1						
136FB	3'-0"	7'-0"	D1	F1	H2	J1				
136GA	3'-0"	7'-0"	EX	EX						
136HA	3'-0"	7'-0"	D1	F1	H3	J2				
136JA	3'-0"	7'-0"	D2	F1	H3	J2				
136KA	3'-0"	7'-0"	D1	F1	H3	J2				
147A	3'-0"	7'-0"	EX	EX						
H124A	3'-0"	7'-0"	EX	EX						
H124B	3'-0"	7'-0"	EX	EX						
H124D	3'-0"	7'-0"	EX	EX	H1	J1				

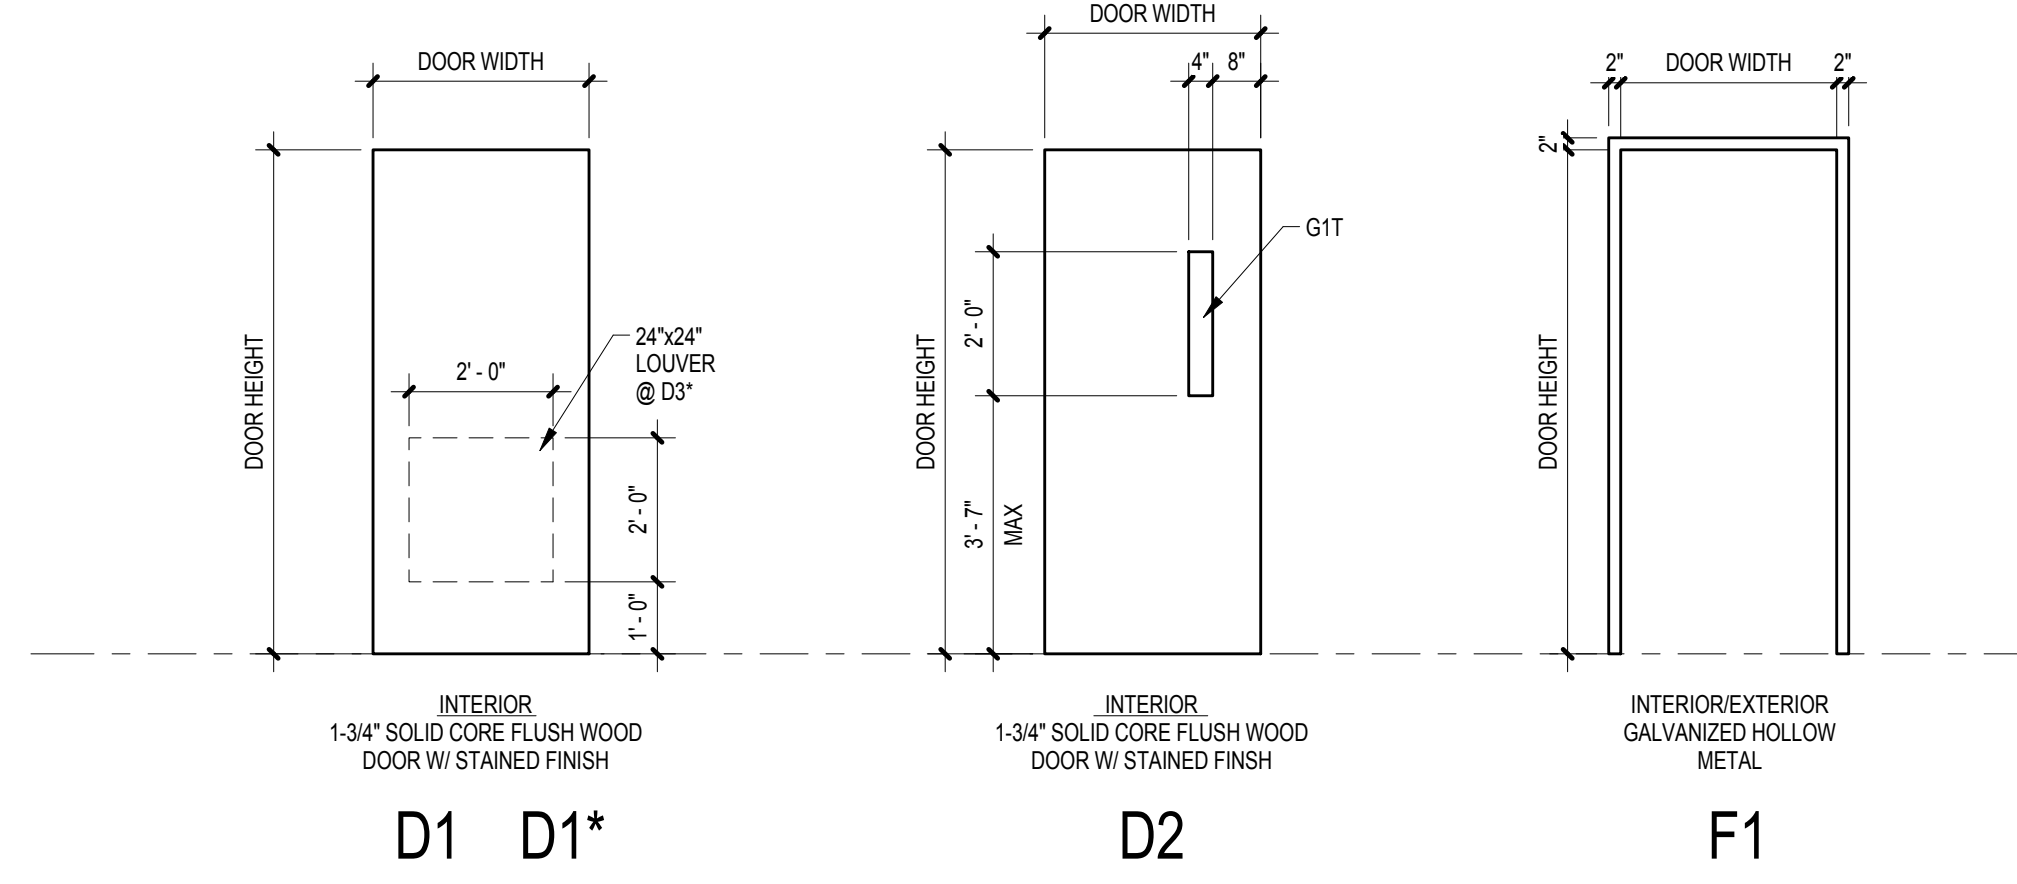


DOOR/ FRAME TYPES


LEGEND - GLAZING TYPES

GLASS TYPE	DISCRPTION
G1	1/4-INCH CLASS 1 CLEAR FLOAT GLASS
G1T	SAME AS G1 WITH 1/4\"/>


NOTES:
 1. SEE SPECIFICATIONS FOR ADDITIONAL GLASS TYPE INFORMATION.
 2. PROVIDE SAFETY OR TEMPERED GLASS WHERE REQUIRED BY CURRENT INTERNATIONAL BUILDING CODE.

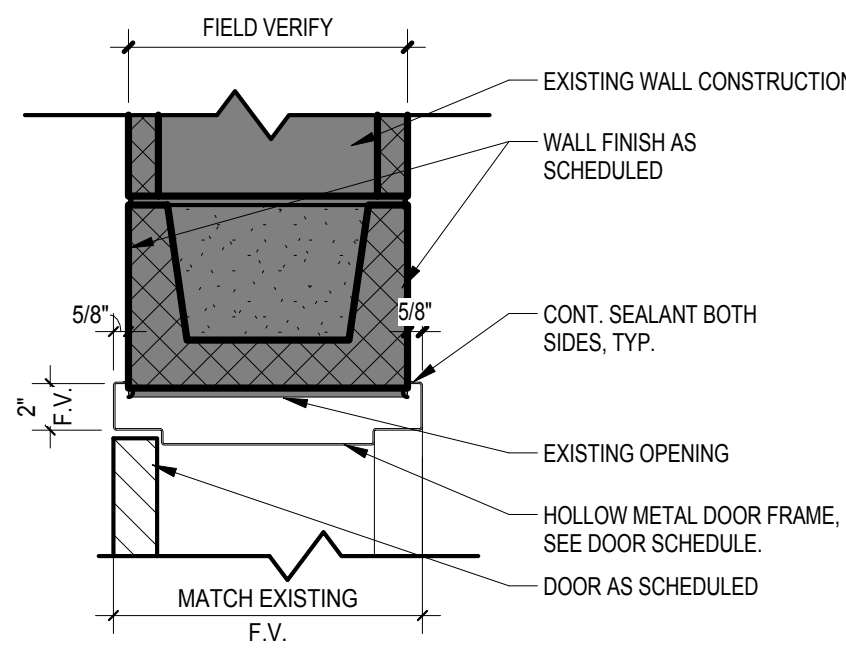


H1 HEAD SECTION DETAIL

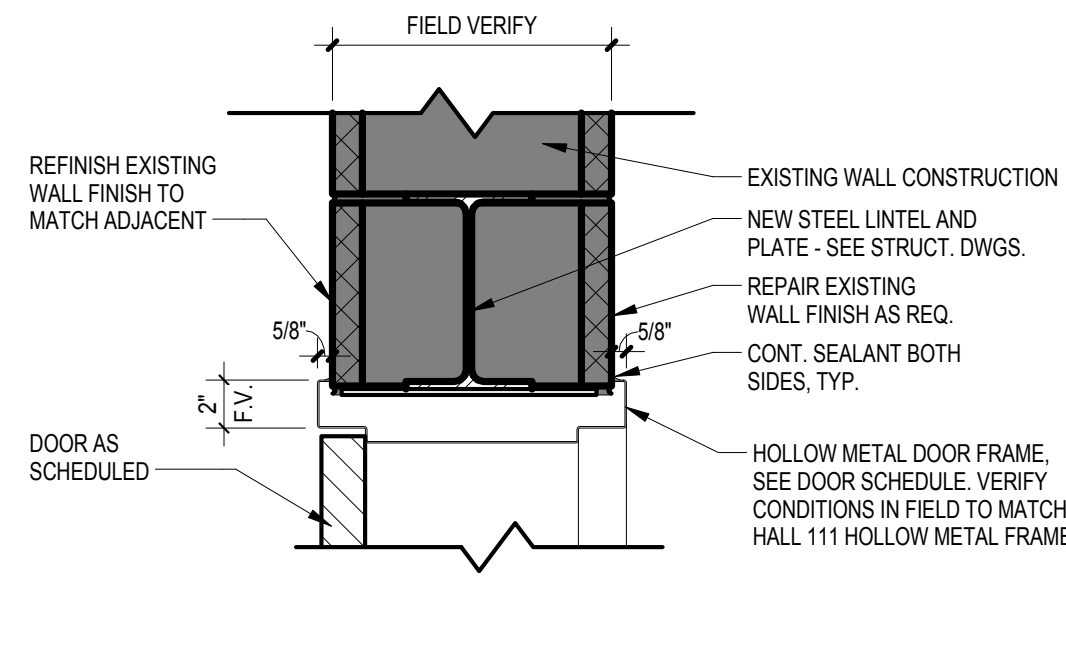


H2 HEAD SECTION DETAIL

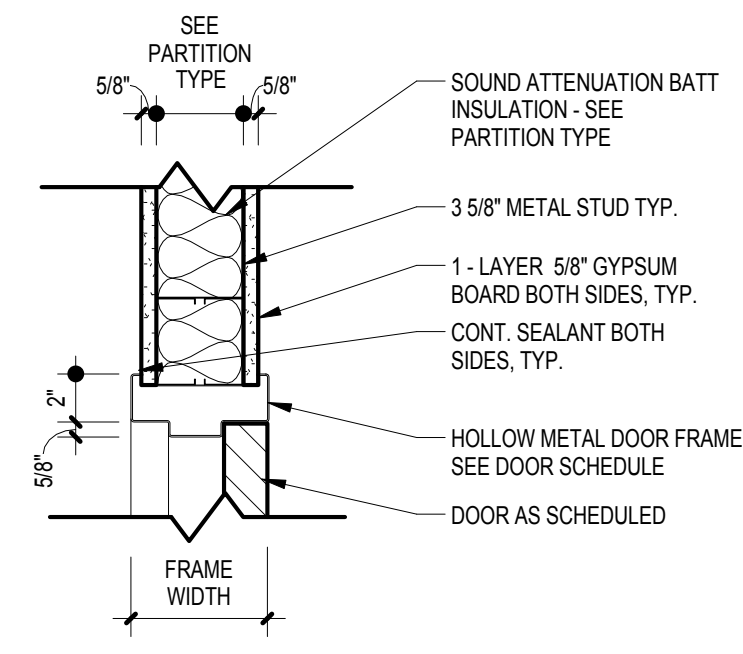


H3 HEAD SECTION DETAIL

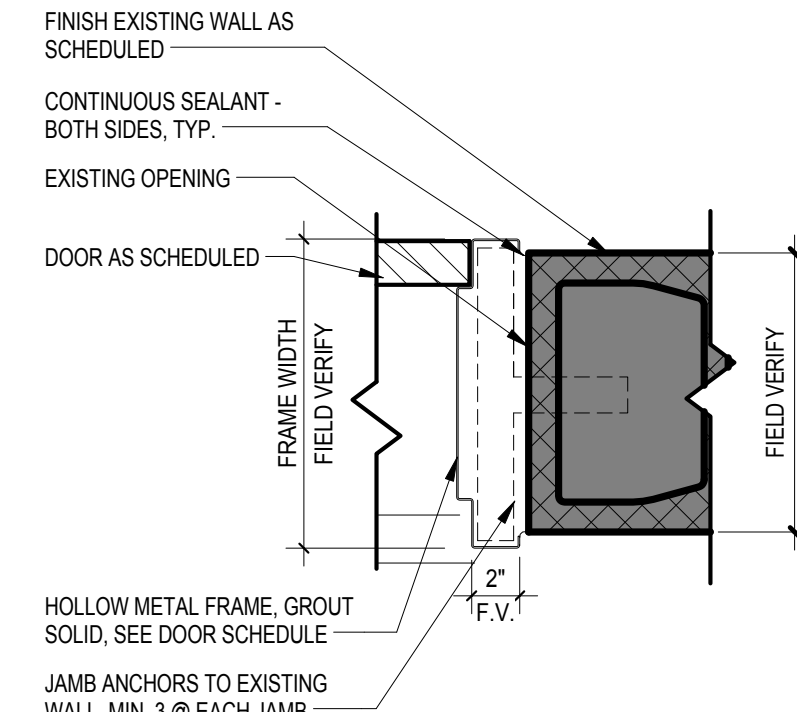


J1 JAMB PLAN DETAIL

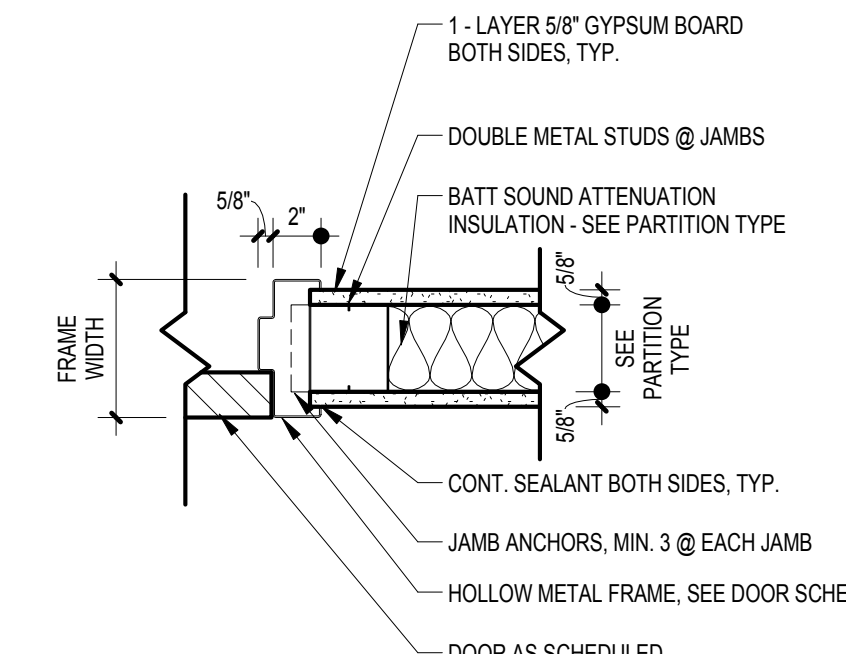


J2 JAMB PLAN DETAIL

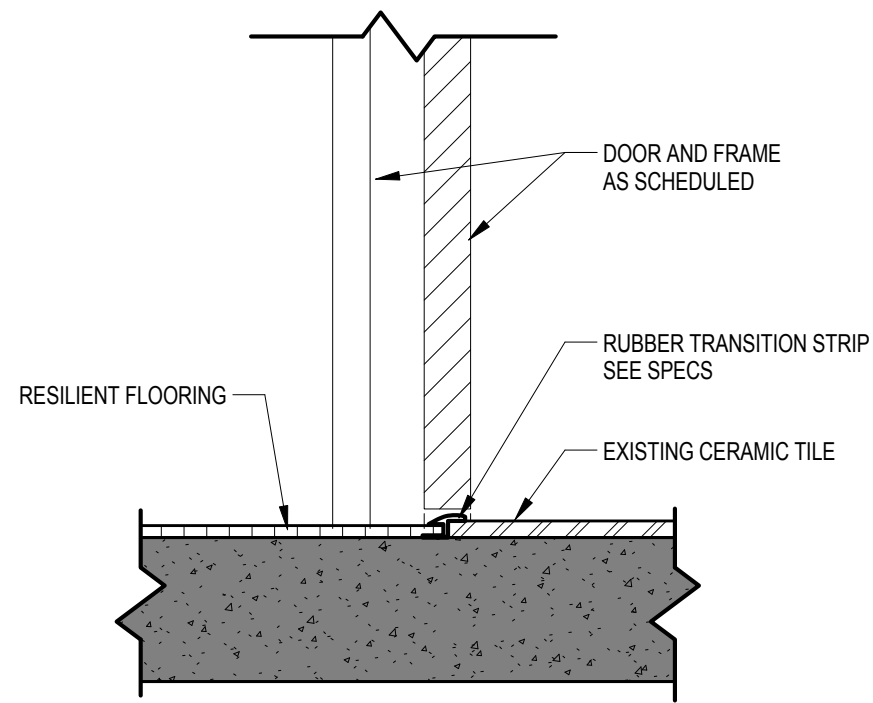


1 FT1

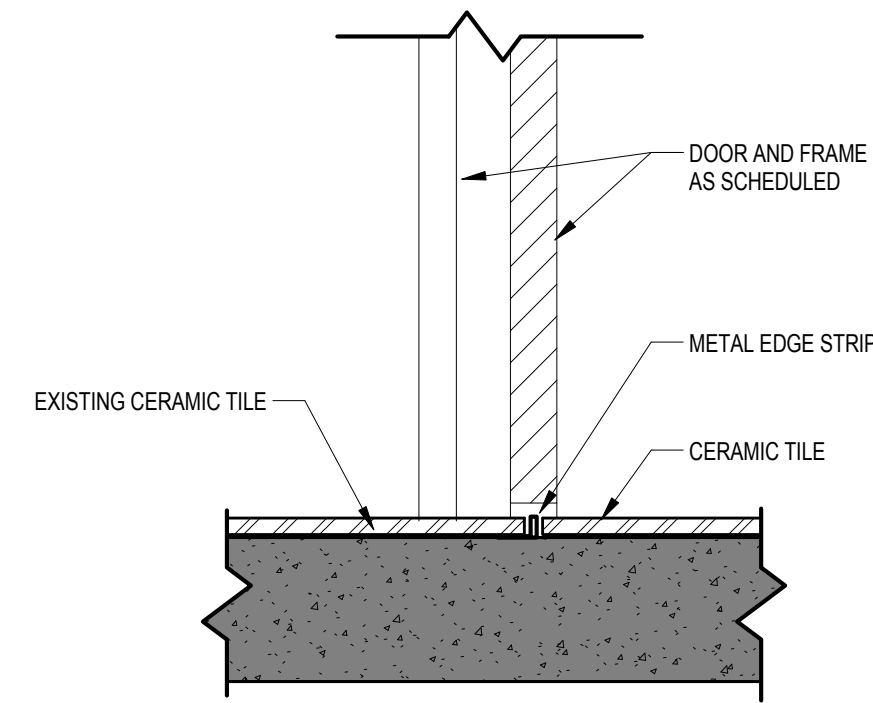


2 FT2

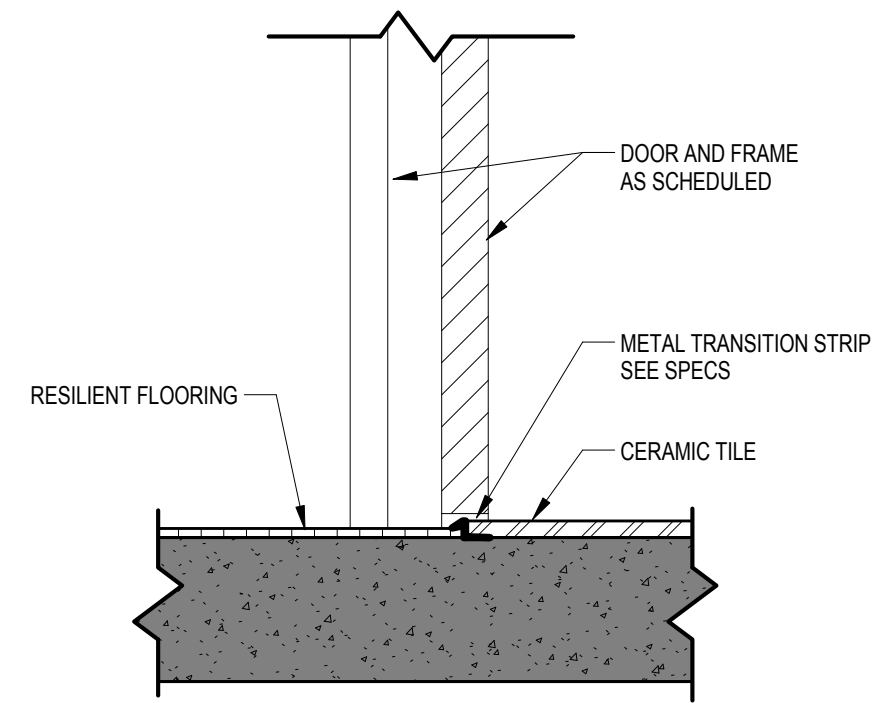

3 FT3

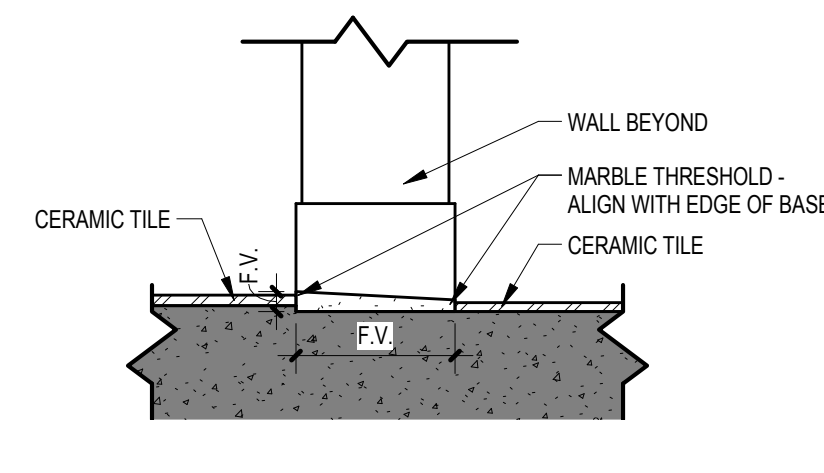

4 FT4

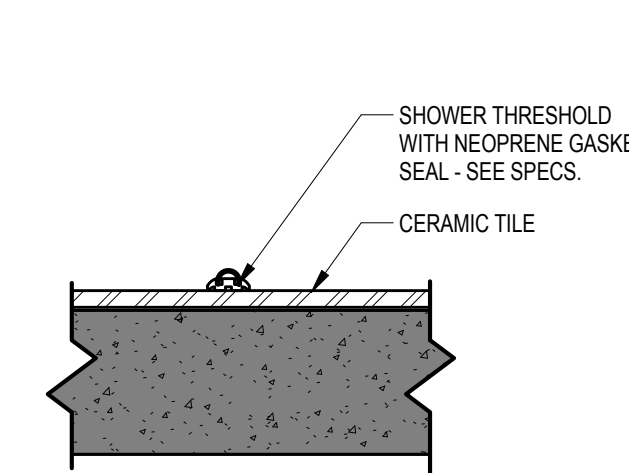

5 FT5

NO.	REVISIONS	DATE

DRAWN BY:
 CHECKED BY:
 AUTHZ:
 CHGK:
THIS DRAWING IS THE PROPERTY OF GARVIN DESIGN GROUP. IT IS TO BE USED ONLY FOR THE PROJECT AND LOCATION SPECIFICALLY IDENTIFIED ON THE DRAWING. ANY REPRODUCTION OR TRANSMISSION OF THIS DRAWING WITHOUT THE WRITTEN PERMISSION OF GARVIN DESIGN GROUP IS STRICTLY PROHIBITED. ©2011 GARVIN DESIGN GROUP, INC.



1 FIRST FLOOR PLAN
 A8.1 1/4" = 1'-0" REFERENCED ON: A3.1

FINISH SCHEDULE - LOCKER ROOMS/TEAM ROOM									
ROOM NO.	ROOM NAME	BASE	FLOOR	WALL FINISH NORTH	WALL FINISH EAST	WALL FINISH SOUTH	WALL FINISH WEST	CEILING	COMMENTS
127	MEN'S LOCKER ROOM	CTB-1	CT-1,3,5,RF-2	CT-2,P-1	P-1	P-1	P-1	EXP STR/P-1, AC	2,7
127A	SHOWERS	CTB-1	CT-1	CT-2,4	CT-2,4	CT-2,4	CT-2,4	APC-1,PL/P-1,GB/P-1	
127B	TOILETS	CTB-1	CT-1	CT-2	P-1	CT-2	CT-2	APC-1,PL/P-1,GB/P-1	
127C	MEN'S COACH	CTB-1	CT-1	P-2	P-2	P-2	P-2	APC-1,GB/P-1	2
127D	TOILET	CTB-1	CT-1	CT-2,P-2	P-2	CT-2,P-2	CT-2,P-2	APC-1,PL/P-1,GB/P-1	7
127E	STORAGE	CTB-1	CT-1	P-1	P-1	P-1	P-1	APC-2	
133	STORAGE	--	--	--	--	--	--	EXP STR	
133A	STORAGE	--	--	--	--	--	--	EXP STR	
133B	STORAGE	--	--	--	--	--	--	EXP STR	
136	WOMEN'S LOCKER ROOM	CTB-1	CT-1,3,5,RF-2	P-1	P-1	P-1	P-1	EXP STR/P-1, AC	2,5,7
136A	WOMEN'S COACH	CTB-1	CT-1	P-2,CT-2	P-2	P-2,CT-2	P-2,CT-2	APC-1,PL/P-1,GB/P-1	2,7
136B	TOILETS	CTB-1	CT-1	P-1	CT-4	P-1	P-1	APC-1	
136C	TOILETS	CTB-1	CT-1	P-1	P-1	P-1	CT-4	APC-1	
136D	CORRIDOR	CTB-1	CT-1	CT-2	P-1	CT-4,P-1	CT-2,P-1	APC-1	
136E	SHOWERS	CTB-1	CT-1	CT-2	CT-4,P-1	CT-2	CT-4,P-1	APC-1,PL/P-1	7
136F	TEAM ROOM	RB-1	RF-1	P-2, WG*	P-2	P-2	P-2	APC-2	3
136G	STORAGE	RB-1	RF-1	P-2	P-2	P-2	P-2	APC-2	
136H	STORAGE	RB-1	RF-1	P-2	P-2	P-2	P-2	APC-2	
136J	VESTIBULE	RB-1	RF-1	P-2	P-2	P-2	P-2	APC-2	
136K	STORAGE	RB-1	RF-1	P-2	P-2	P-2	P-2	APC-2	
150	NATATORIUM	--	--	--	--	--	--	--	
H103	HALL	--	--	--	--	--	--	--	8
H104	HALL	--	--	--	--	--	P-EX	--	6,8
H106	HALL	--	--	--	--	--	P-EX	--	6,8
H111	HALL	--	--	--	--	--	P-EX	--	6,8
H115	HALL	--	--	--	--	--	P-EX	--	6,8
H124	HALL	--	EX CT-1	P-1	P-1	P-1	P-1	APC-1	
ST04	STAIR	--	--	--	--	--	--	--	

SCHEDULED INTERIOR FINISHES		
ABBREVIATION	DESCRIPTION	MANUFACTURER, COLOR, STYLE
BASE		
CTB-1	CERAMIC TILE BASE, COVERED	AMERICAN OLEAN, 4X6 GLOSS BLACK #0049
RB-1	RESILIENT BASE	JOHNSONITE RECESS WALL BASE, COLOR #40 BLACK
FLOORS		
RSF-1	RESILIENT FLOORING	FORBIO, FLOTEX CAL GARY #200010 ASH
RSF-2	RESILIENT FLOORING-AREA RUGS	FORBIO, FLOTEX SENTA #234048 RED
CT-1	CERAMIC TILE - GREY SPECKLED	AMERICAN OLEAN, 2X2 MOSAIC, COLOR A34 LIGHT SMOKE SPECKLED
CT-3	CERAMIC TILE - BLACK	AMERICAN OLEAN, 2X2 MOSAIC, COLOR A34 BLACK
CT-5	CERAMIC TILE - GARNET	AMERICAN OLEAN, 2X2 MOSAIC, COLOR A42 CINNABAR
WALLS		
CT-2	CERAMIC TILE	AMERICAN OLEAN, 4X4 CERAMIC, COLOR: 0095 SNOW MIST
CT-4	CERAMIC TILE	AMERICAN OLEAN, 4X4 CERAMIC, COLOR: 0072 POMEGRANATE
P-1	PAINT - "WHITE" - EGGSHELL (FLAT CEILINGS)	TO MATCH SHERWIN WILLIAMS SW7827 "ZURICH WHITE"
P-2	PAINT - "GRAY" - EGGSHELL	TO MATCH SHERWIN WILLIAMS SW7015 "REPOSE GRAY"
P-3	PAINT - "GARNET" - SEMI-GLOSS	TO MATCH SHERWIN WILLIAMS SW7583 "CRABBY APPLE"
P-4	PAINT - "BLACK" - SEMI-GLOSS TRIM	TO MATCH SHERWIN WILLIAMS SW684 "TRICORN BLACK"
P-5	PAINT - "EX GARNET" - SEMI-GLOSS	TO MATCH SHERWIN WILLIAMS SW6328 FIREWEED
CEILINGS		
APC-1	MOISTURE GUARD CEILING TILE	ARMSTRONG CERAMAGUARD, #607 OR APPROVED EQ.
APC-2	STANDARD CEILING TILE	ARMSTRONG GEORGIAN, #794 OR APPROVED EQ.
DAC	DECORATIVE ACCENT CANOPIES	ARMSTRONG INFUSIONS #54061 24X30 APC PANEL, 54062, CABLES-CHANNELED CARIBBEAN PLASTER CEILING, PAINTED, P-1, SEE SPEC.
CASEWORK		
SS-1	SOLID SURFACE LAYS AND CAPS	WILSONART GIBRALTAR - STARBUST SPECTRA #5098ST
SS-2	SOLID SURFACE THRESHOLDS	WILSONART GIBRALTAR - PARIS FOG #9110CS
SP	SOLID PHENOLIC-FACE CORE	MFR. STD. BLACK
MISCELLANEOUS		
HMP	HOLLOW METAL FRAMES - PAINTED	PAINT TO MATCH P-4 "BLACK" - INCLUDES ALL DOORS TO RENOVATED SCOPE
WG	WALL GRAPHIC	INSTALLED BY OTHERS, N.L.C. - PAINT EG-SHELL BENEATH
TP	TOILET PARTITIONS	SCANTON PRODUCTS, SOLID PLASTIC, COLOR: BURGUNDY OR APPD EQ COLOR

- COMMENTS
- PAINT ALL CEILING SURFACES, EXPOSED DUCTS AND CONDUIT, P-1.
 - PAINT WALLS TO RECEIVE LOCKERS 1/8" INSIDE LOCKER PERIMETER DIMENSIONS, AND TO FULL EXTENT OF WALL ABOVE AND BESIDE LOCKERS.
 - WALL GRAPHIC (WG) TO BE COORDINATED BY OWNER, PAINT P-1 ON SUBSTRATE
 - PAINT ALL DOORS AND FRAMES IN SCOPE. AT INTERIOR DOORS (INSIDE THIS SCOPE) PAINT DOORS, P-3 BOTH SIDES, U.N.O.; ALL DOORS TO EXISTING CORRIDORS, TO MATCH ADJACENT DOOR COLOR; ALL FRAMES, P-4, TYP.
 - RF-2 "AREA RUGS" ARE CUT AND SEALED TO SIZES INDICATED, FREE LAY ON TILE FLOOR, NO GLUE.
 - PAINT EXISTING WALLS AT AREA OF NEW DOOR/FRAME CONSTRUCTION, TO NEAREST CORNER. MATCH COLOR AND SHEEN OF EXISTING FINISH.
 - PAINT WOOD TRIM RAIL FOR SHOWER HOOKS, MATCH ADJACENT WALL SURFACE.
 - CEILING MODIFICATION REQUIRED FOR MECHANICAL WORK, REMOVE/REPLACE AS REQUIRED; MATCH EXISTING. SEE RCP.

PROJECT TITLE
SWIM TEAM LOCKER ROOM RENOVATIONS

University of South Carolina
 Solomon Blatt Physical Education Center
 1300 Wheat Street
 Columbia, SC 29208 USC
 Project No. H27-Z158


NO.	REVISIONS	DATE

DRAWN BY: _____
 CHECKED BY: _____
 AUTHZ: _____
 CHKD: _____

DRAWING TITLE
FINISH PLANS AND SCHEDULES

PROJECT NO. U028.13
 DATE 04.30.14
 DRAWING NO. **A8.1**



N:\PROJECTS\13255\DRAWINGS\HVAC\13255-MD1.dwg

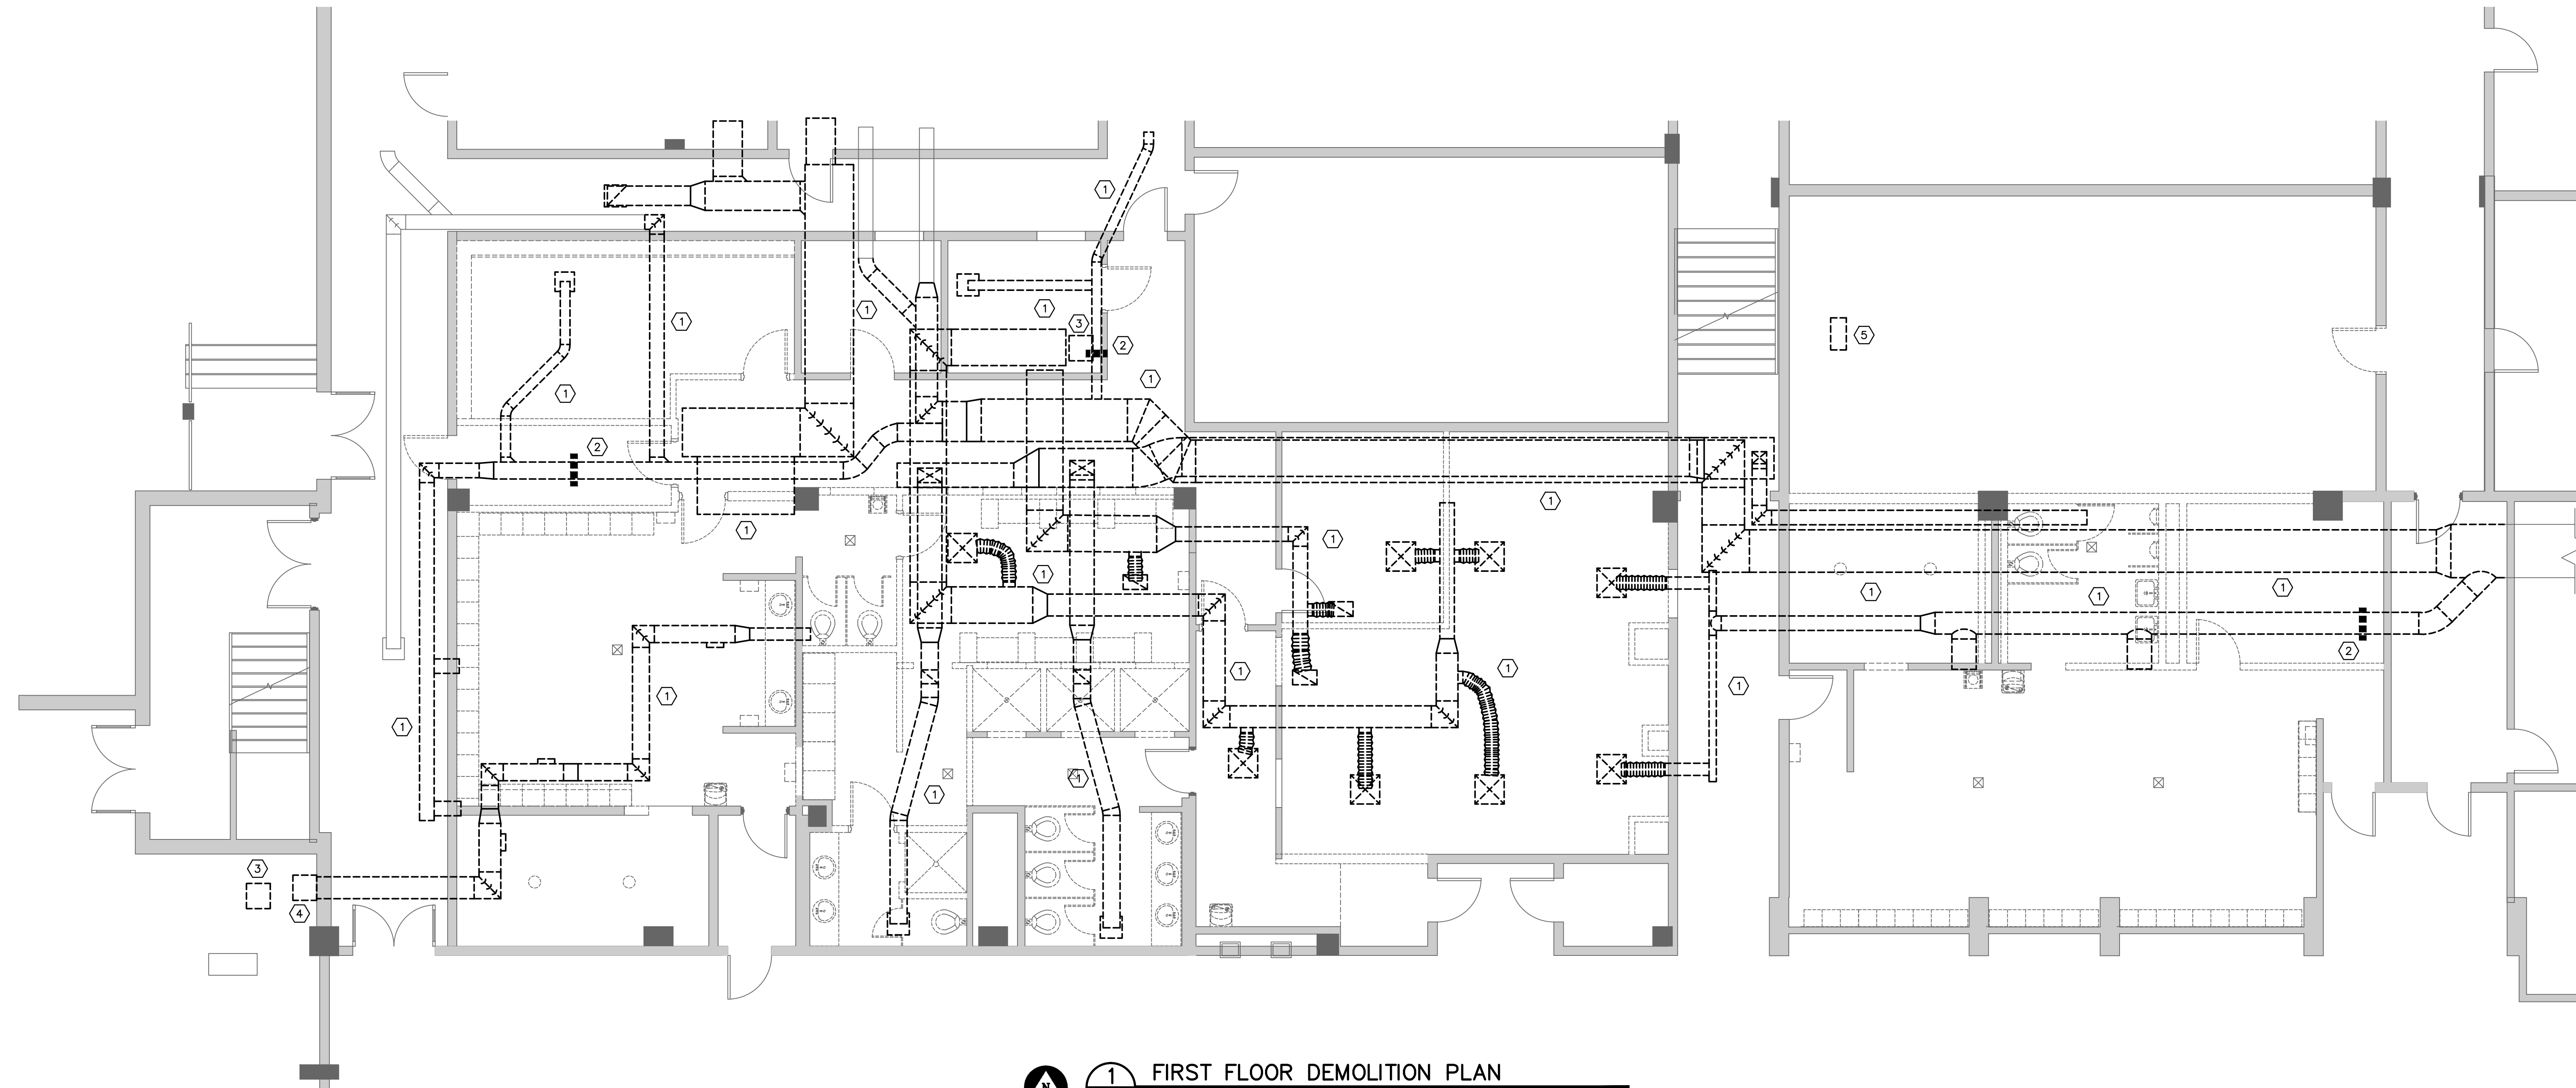

- DEMOLITION NOTES**
- ① REMOVE ALL DUCTWORK AS SHOWN COMPLETE, INCLUDING BUT NOT LIMITED TO DUCT AND GRILLES.
 - ② REMOVE HOT WATER COILS COMPLETE, INCLUDING BUT NOT LIMITED TO WIRING, CONTROLS AND PIPING. CAP PIPING BACK AT MAINS.
 - ③ REMOVE SPLIT SYSTEM COMPLETE, INCLUDING BUT NOT LIMITED TO DUCTWORK PIPING, CONTROLS, WIRING AND REFRIGERANT.
 - ④ REMOVE EXHAUST FAN COMPLETE.
 - ⑤ REMOVE SUPPLY GRILLE IN RACQUETBALL COURT AND CAP WITH SHEET METAL COVER AND SEAL AIR TIGHT.

1 FIRST FLOOR DEMOLITION PLAN
 MD1.1 SCALE: 3/16" = 1'-0"

Swygart & Associates
 CONSULTING ENGINEERS
 DBA Swygart & Assoc., Ltd. Telephone: (803) 791-9300
 Post Office Box 11686 Fax: (803) 791-0830
 Columbia, S.C. 29211 mail@swygart-associates.com

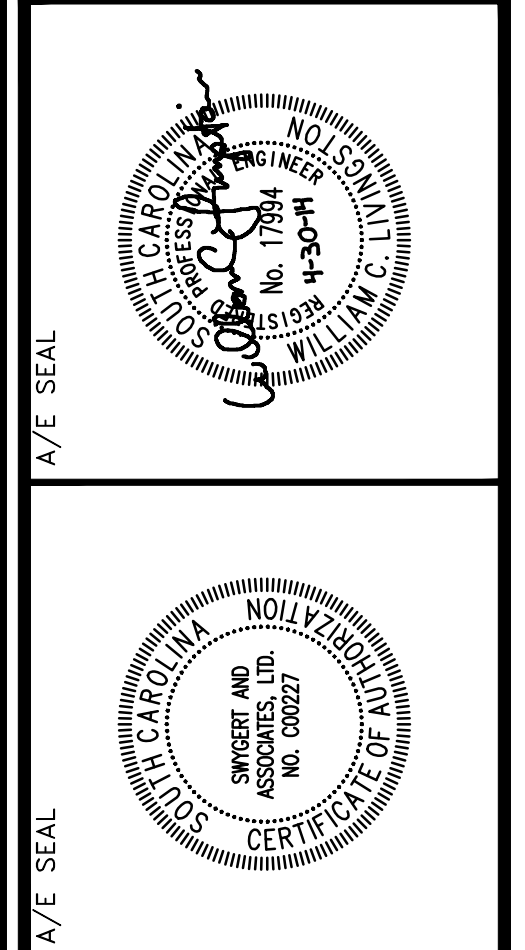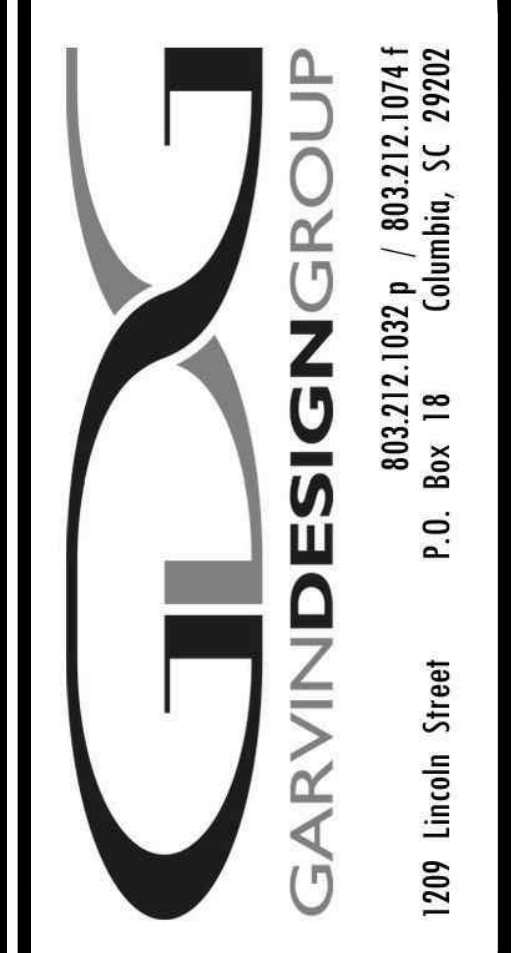

PROJECT TITLE
SWIM TEAM LOCKER ROOM RENOVATIONS
 University of South Carolina
 Solomon Blatt Physical Education Center
 1300 Wheat Street
 Columbia, SC 29208 USC
 Project No. H27-Z158

NO.	NAME	DATE

STANDARD CONTRACT AGREEMENT
 BETWEEN SWYGART & ASSOCIATES, INC.
 AND UNIVERSITY OF SOUTH CAROLINA
 FOR THE RENOVATION OF THE
 SWIM TEAM LOCKER ROOM
 PROJECT NO. H27-Z158
 2009 SWYGART & ASSOCIATES, INC.


DRAWING TITLE
FIRST FLOOR DEMOLITION PLAN

PROJECT NO. 13255.13
DATE 04.30.14
DRAWING NO. MD1.1


NOTES TO SHEET

- 1 EXTEND AND CONNECT HOT WATER PIPE TO EXISTING MAINS.
- 2 10"x10" EXHAUST DUCT RISES ABOVE CEILING IN SHOWER 136E.
- 3 10"Ø SUPPLY DUCT RISES ABOVE CEILING IN STORAGE 136H.
- 4 26"x12" EXHAUST DUCT RISES ABOVE CEILING IN SHOWER 127A.
- 5 30"x12" EXHAUST DUCT DROPS UNDER BEAM.
- 6 12"Ø SUPPLY DUCT RUNS UNDER BEAM AND RISES ABOVE EXHAUST DUCT.
- 7 14"x12" EXHAUST DUCT DROPS BELOW BEAM.
- 8 14"x12" EXHAUST DUCT RISES UP ABOVE SUPPLY DUCT.
- 9 44"x12" SUPPLY DUCT DROPS BELOW CONCRETE BEAM.
- 10 44"x12" SUPPLY DUCT RISES ABOVE EXHAUST DUCT TIGHT TO BEAM ABOVE.
- 11 44"x12" SUPPLY DUCT RISES ABOVE CEILING IN MEN'S COACH 127.

NOTE:
 EXISTING AHU-3 SHALL BE AIR
 BALANCED TO 6,000 CFM.
 EXISTING VAV BOXES/COILS SHALL BE
 AIR BALANCED TO THE FOLLOWING:
 3-1 = 1550 CFM MAX, 470 CFM MIN
 3-2 = 700 CFM MAX, 210 CFM MIN
 RH COIL 2 = 80 CFM
 RH COIL 1B = 680 CFM

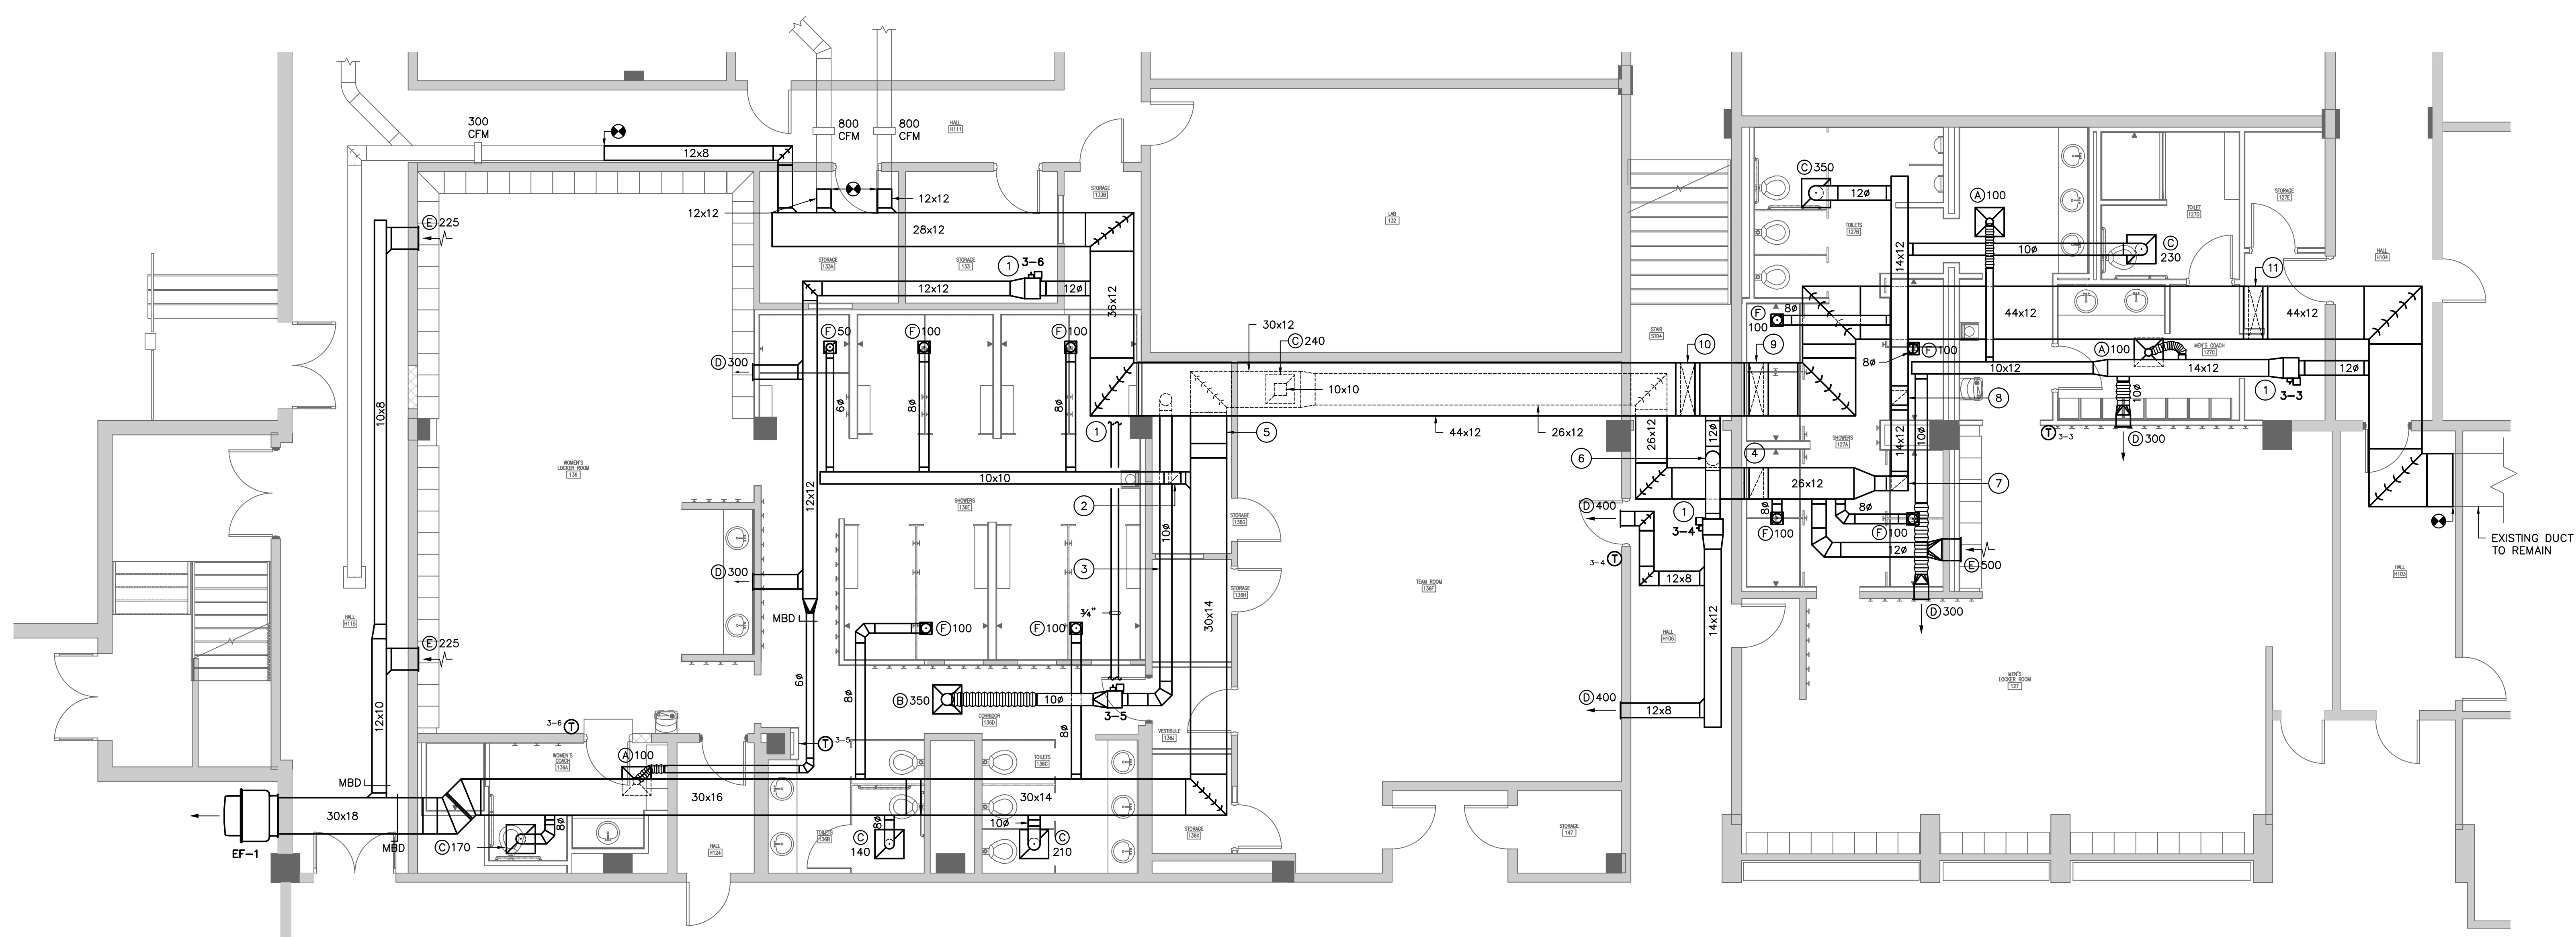

1 FIRST FLOOR PLAN
 M1.1 SCALE: 3/16" = 1'-0"

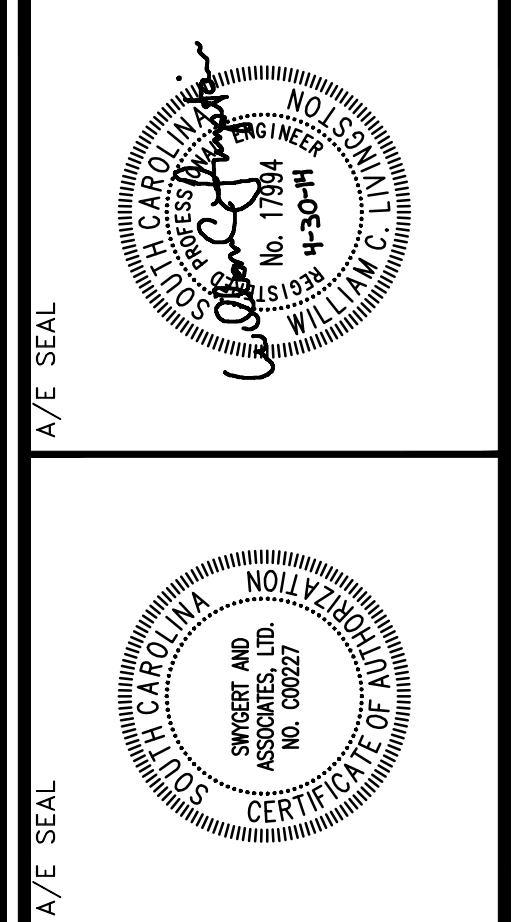

PROJECT TITLE
SWIM TEAM LOCKER ROOM RENOVATIONS
 University of South Carolina
 Solomon Blatt Physical Education Center
 1300 Wheat Street
 Columbia, SC 29208 USC
 Project No. H27-Z158


REVISIONS	NO.	NAME	DATE

DRAWING TITLE
FIRST FLOOR PLAN

Swygert & Associates
 CONSULTING ENGINEERS
 DBA Swygert & Assoc., Ltd. Telephone: (803) 791-9300
 Post Office Box 11866 Columbia, S.C. 29211 Fax: (803) 791-0830
 mail@swygert-associates.com


PROJECT NO. 0328.13
DATE 04.30.14
DRAWING NO. **M1.1**

NOTE:
EXISTING AHU-3 SHALL BE AIR
BALANCED TO 6,000 CFM
EXISTING VAV BOXES/COILS SHALL BE
AIR BALANCED TO THE FOLLOWING:
3-1 - 1550 CFM MAX, 470 CFM MIN
3-2 - 700 CFM MAX, 210 CFM MIN
RH COIL 2 - 80 CFM
RH COIL 18 - 680 CFM

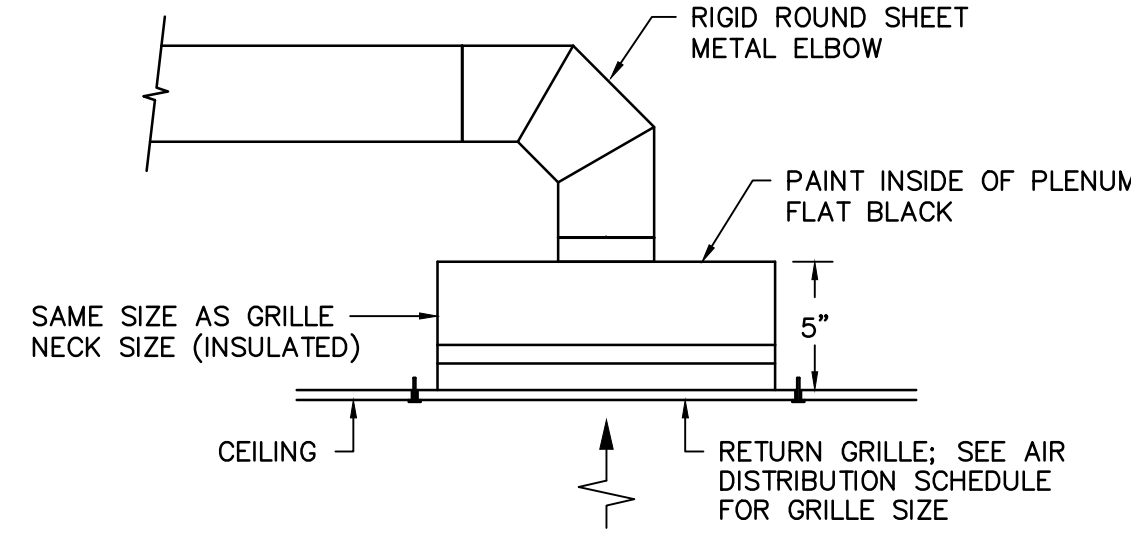


EXHAUST GRILLE DETAIL

NO SCALE

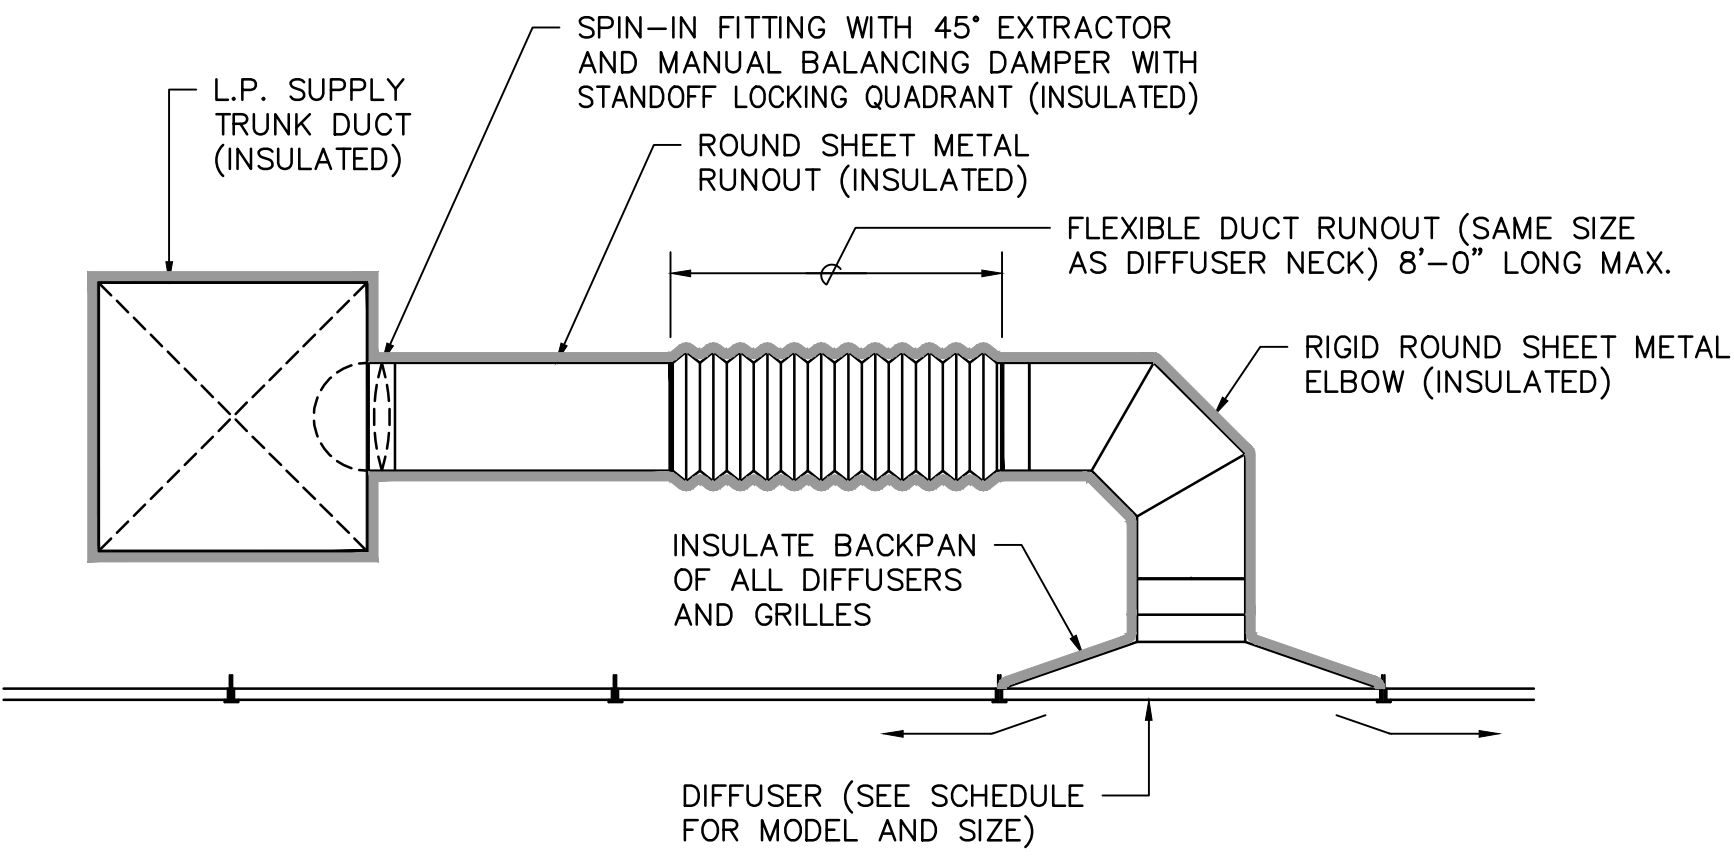

CEILING DIFFUSER DETAIL

NO SCALE

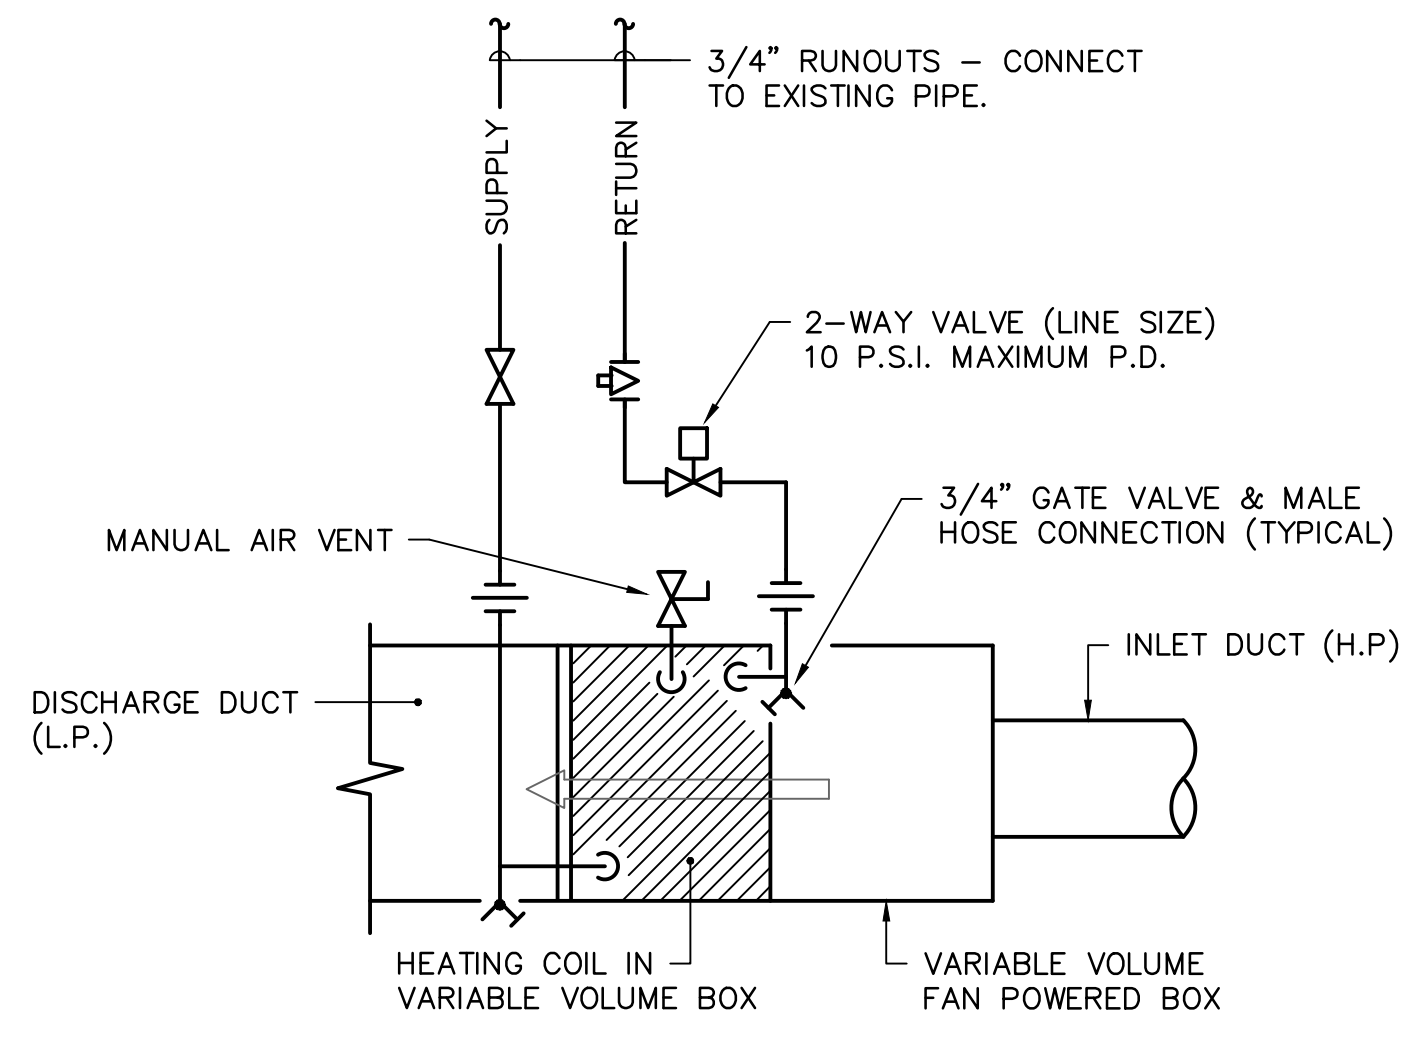

HOT WATER HEATING COIL PIPING DETAIL

NO SCALE

VARIABLE VOLUME BOX SCHEDULE

TAG	ENVROTECH MODEL	AIR INLET (NOM. DIA.)	CFM		HEATING COIL		MAX. UNIT P.D. INCHES W.C.	MAX. NC LEVEL	REMARKS
			MAX/MIN	HEATING	MBH	GPM			
3-3	SDR	12"ø	800/800	800	37.3	2.5	0.25	30	1,2
3-4	SDR	12"ø	800/240	240	15.8	1.1	0.25	30	1,2
3-5	SDR	10"ø	350/350	350	21.7	1.5	0.25	30	1,2
3-6	SDR	12"ø	700/700	700	34.0	2.3	0.25	30	1,2

- HEATING COIL SELECTION BASED ON 150°F EWT WITH 30°F DROP.
- PROVIDE WITH STAND ALONE JOHNSON CONTROLS CONTROLLER, CONTROL VALVE AND WALL MOUNTED THERMOSTAT.

AIR DISTRIBUTION SCHEDULE

TAG	DESCRIPTION	MANUFACTURER	MODEL	FRAME	CFM	NECK SIZE	FACE SIZE	MAX NC	REMARKS
(A)	UNI-FLOW SUPPLY	PRICE	ASPD	LAY-IN	0-125	6"ø	24"x24"	30	1,2
(B)	UNI-FLOW SUPPLY	PRICE	ASPD	LAY-IN	251-350	10"ø	24"x24"	30	1,2
(C)	PERFORATED EXHAUST	PRICE	APDDR	LAY-IN	0-1000	22"x22"	24"x24"	30	1,2
(D)	SIDEWALL SUPPLY	PRICE	620	SURFACE	300-400	12"x8"	14"x10"	30	1,2,3
(E)	SIDEWALL RETURN	PRICE	630	SURFACE	0-500	18"x8"	20"x10"	30	1,2
(F)	PERFORATED EXHAUST	PRICE	APDDR	SURFACE	0-100	10"x10"	12"x12"	30	1,2,3

- PROVIDE WITH STANDARD WHITE FINISH.
- PROVIDE ALUMINUM OR ALUMINIZED STEEL CONSTRUCTION.
- PROVIDE WITH OPPOSED BLADE DAMPER.

EXHAUST FAN SCHEDULE

TAG	GREENHECK MODEL NO.	TYPE	CFM	ESP	MOTOR H.P./W	SONES (MAX.)	REMARKS
EF-1	CWB-180-7	SIDEWALL	3140	0.5	3/4	15.4	1,2




- PROVIDE SIDEWALL CENTRIFUGAL FAN WITH BELT DRIVE, ALUMINUM CONSTRUCTION AND NEMA 1 TOGGLE SWITCH.
- INTERLOCK WITH AHU-3 OPERATION.

LEGEND

SYMBOL	DESCRIPTION
↔ HWS ↔	HOT WATER SUPPLY LINE
↔ HWR ↔	HOT WATER RETURN LINE
(A)100	TYPE "A" DIFFUSER, 100 CFM
⊕	THERMOSTAT
⊠	RECTANGULAR SUPPLY DUCTWORK
⊡	RETURN, EXHAUST, FRESH AIR DUCTWORK
48x24	48"x24" RECTANGULAR DUCT
⊕	CONNECTION POINT OF NEW TO EXISTING
▶	1" DOOR UNDERCUT BY GENERAL CONTRACTOR

GENERAL NOTES

- VISIT SITE PRIOR TO BIDDING. THIS CONTRACTOR SHALL DETERMINE DIFFICULTY OF INSTALLATION AND REFLECT THIS IN HIS BIDDING.
- DO NOT SCALE DRAWINGS. SEE ARCHITECTURAL DRAWINGS AND REFLECTED CEILING PLANS FOR EXACT LOCATIONS OF DOORS, WINDOWS, AIR DISTRIBUTION, ETC.
- DO NOT SCALE DRAWINGS. THIS CONTRACTOR SHALL VERIFY ALL EXISTING ITEMS AND LOCATIONS IN THE FIELD.
- ALL PIPING AND DUCTWORK LOCATIONS SHALL BE COORDINATED WITH WORK UNDER OTHER DIVISIONS OF THE SPECIFICATIONS TO AVOID INTERFERENCE.
- EXISTING PIPE, DUCTWORK, CONDUIT, ETC THAT INTERFERES WITH THE ROUTING OF NEW SYSTEMS SHALL BE RELOCATED. THIS CONTRACTOR SHALL INCLUDE THE COST OF SUCH IN HIS BID UNLESS NOTED OTHERWISE.
- WATER SYSTEMS SHALL BE DRAINED AS REQUIRED FOR INSTALLATION OF WORK. UPON COMPLETION, SYSTEM SHALL BE FILLED WITH WATER AND VENTED OF ALL AIR.
- ALL PIPING AND DUCTWORK INSULATION SHALL BE RUN CONTINUOUSLY THROUGH FLOORS, ROOFS AND PARTITIONS.
- ALL MECHANICAL ITEMS EXTENDING THROUGH WALLS SHALL BE FLASHED AND COUNTERFLASHED.
- ALL PIPING IS SHOWN DIAGRAMMATIC. HOWEVER, THIS CONTRACTOR SHALL PROVIDE ALL REQUIRED FITTINGS, PIPING AND INSULATION FOR ALL OFFSETS AND/OR CHANGES IN ELEVATION.
- ALL VALVES AND SPECIALTIES SHALL BE LINE SIZE UNLESS NOTED OTHERWISE, USING ECCENTRIC REDUCERS ON PUMP SUCTION AND CONCENTRIC REDUCERS ON PUMP DISCHARGE. USE ECCENTRIC REDUCERS ON AUTOMATIC VALVES AS REQUIRED.
- MINIMUM PIPE SIZE SHALL BE 3/4-INCH UNLESS INDICATED OTHERWISE.
- ALL PIPING SHALL BE SUPPORTED IN ACCORDANCE WITH THE SPECIFICATIONS AND FURTHER SUPPORTS OR HANGERS SHALL BE PROVIDED TO PREVENT WEIGHT OF PIPING BEING PLACED ON EQUIPMENT.
- SPACE ABOVE CEILING TO BE USED AS RETURN AIR PLENUM WHERE DUCT IS NOT INDICATED ABOVE RETURN AIR GRILLES.
- ALL OPEN END DUCTS SHALL HAVE 1/4-INCH MESH GALVANIZED SCREEN IN REMOVABLE FRAME.
- PROVIDE FOR ACCESS TO ALL EQUIPMENT REQUIRING CLEANING OR ADJUSTMENT.
- INSTALL ALL VAV BOXES WITHIN 24" OF CEILING TO ALLOW FOR SERVICE ACCESS.
- THIS CONTRACTOR SHALL PROVIDE ALL ITEMS OF MISCELLANEOUS STEEL AS REQUIRED FOR INSTALLATION OF ALL MECHANICAL ITEMS.
- THIS CONTRACTOR SHALL DO ALL CONTROL WIRING AND PROVIDE TRANSFORMER TO CONTROL POWER AS REQUIRED. DIVISION 16 WILL DO ALL POWER WIRING. ALL WIRING SHALL BE IN ACCORDANCE WITH NATIONAL ELECTRIC CODE. CONTROL WIRING SHALL BE CONCEALED WITHIN WALL.
- LOCATE ALL SPACE CONTROL INSTRUMENTS 4'-0" ABOVE FINISHED FLOOR.
- CAP PNEUMATIC LINES AS REQUIRED DURING DEMOLITION TO MAINTAIN OPERABLE SYSTEM.
- CORRECT SETTINGS ON ALL BALANCING FITTINGS SHALL BE PERMANENTLY MARKED. PROVIDE ORANGE FLAGGING RIBBON ON EACH DAMPER HANDLE FOR EASY IDENTIFICATION.
- THIS CONTRACTOR SHALL BE RESPONSIBLE FOR ANY NECESSARY DISMANTLING OF EQUIPMENT TO BE REMOVED. ITEMS REMOVED UNDER THIS CONTRACT SHALL BECOME THE PROPERTY OF THE CONTRACTOR AND SHALL BE DISPOSED OF PROPERLY.
- THE HVAC SYSTEMS SHALL NOT BE OPERATED DURING HEAVY CONSTRUCTION OPERATIONS INCLUDING MASONRY, GYPSUM BOARD SANDING, HEAVY CLEANUP ACTIVITIES, OR OTHER ACTIVITIES THAT CREATE AIRBORNE PARTICLES OR DEBRIS. ALL SYSTEMS SHALL BE CLEAN OF CONSTRUCTION DEBRIS, DUST AND DIRT AT FINAL COMPLETION. DUCT CLEANING AND UNIT/COIL CLEANING SHALL BE PERFORMED IF REQUIRED.

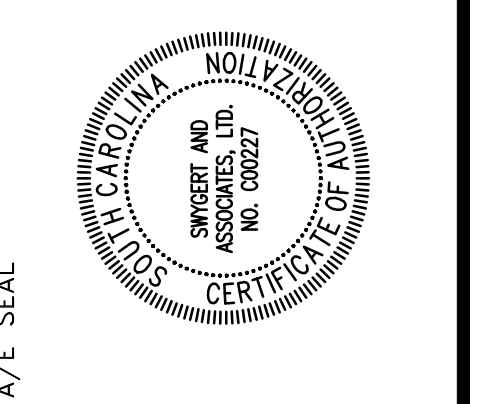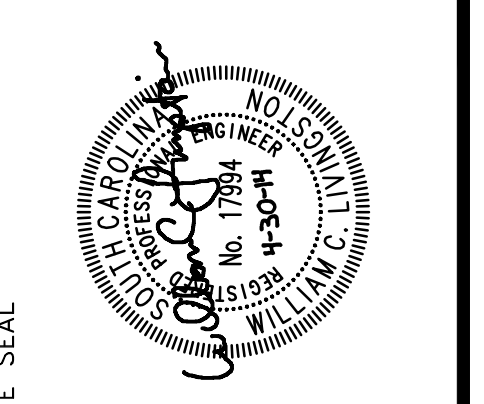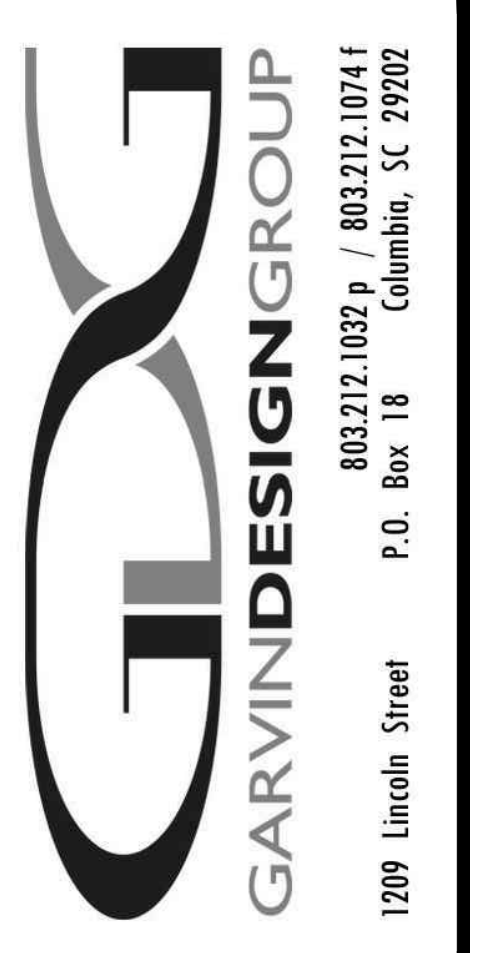

SWIM TEAM LOCKER ROOM RENOVATIONS
University of South Carolina
Solomon Blatt Physical Education Center
1300 Wheat Street
Columbia, SC 29208 USC
Project No. H27-Z-158

REVISIONS	NO.	NAME	DATE
DEM	WCL		

DRAWN BY: WCL
CHECKED BY: WCL

DETAILS, NOTES, SCHEDULES AND LEGEND

PROJECT NO. 13255-13
DATE 04.30.14
DRAWING NO. **M2.1**

Swygert & Associates
CONSULTING ENGINEERS
904 Swygert & Assoc., Ltd. Telephone: (803) 791-9300
Post Office Box 11686 Columbia, S.C. 29211 Facsimile: (803) 791-0830
mail@swygert-associates.com




N:\PROJECTS\13255 DRAWINGS\PLUM\13255-PD1.dwg



- ### DEMOLITION NOTES
- ① EXISTING FLOOR MOUNTED WATER CLOSET TO BE REMOVED COMPLETELY. CAP EXISTING PIPING IN CRAWL SPACE, IN WALL, OR ABOVE CEILING AS REQUIRED.
 - ② EXISTING URINAL TO BE REMOVED COMPLETELY. CAP EXISTING PIPING IN CRAWL SPACE OR ABOVE CEILING AS REQUIRED. REUSE FIXTURE IN NEW LOCATION AS INDICATED ON RENOVATION PLANS.
 - ③ EXISTING LAVATORY TO BE REMOVED COMPLETELY. CAP EXISTING PIPING IN CRAWL SPACE OR ABOVE CEILING AS REQUIRED.
 - ④ EXISTING COLUMN SHOWER UNIT TO BE REMOVED COMPLETELY. CAP EXISTING WASTE LINE IN CRAWL SPACE. REMOVE EXISTING SUPPLY AND VENT PIPING UNTIL THE POINT WHERE NOT VISIBLE BY NEW CEILING AND CAP AS REQUIRED.
 - ⑤ EXISTING STALL SHOWER TO BE REMOVED COMPLETELY. CAP EXISTING PIPING IN CRAWL SPACE OR ABOVE CEILING AS REQUIRED.
 - ⑥ EXISTING WALL HUNG DRINKING FOUNTAIN TO BE REMOVED COMPLETELY. CAP EXISTING PIPING IN WALL AS REQUIRED.
 - ⑦ EXISTING FLOOR DRAIN TO REMAIN. REMOVE AND REINSTALL FOR NEW FLOOR FINISH AS REQUIRED.
 - ⑧ EXISTING SUPPLY LINE TO HOSE BIBB TO BE REMOVED FROM LOCKER AND REINSTALLED IN WALL. COORDINATE WITH NEW LOCKERS.
 - ⑨ EXISTING WALL HUNG WATER CLOSET, FLUSH VALVE, SEAT, AND CARRIER TO BE REMOVED FOR NEW FINISH AND REINSTALLED UPON COMPLETION OF FINISH WORK. SECURE WATER CLOSET TO CARRIER.
 - ⑩ EXISTING COUNTERTOP LAVATORY AND FAUCET TO BE REMOVED FOR NEW COUNTERTOP AND REINSTALLED UPON COMPLETION OF NEW COUNTERTOP.
 - ⑪ EXISTING WALL HUNG WATER CLOSET TO BE REMOVED COMPLETELY. CAP EXISTING PIPING IN CRAWL SPACE, IN WALL, OR ABOVE CEILING AS REQUIRED. REUSE FIXTURE IN NEW LOCATION AS INDICATED ON RENOVATION PLANS.
 - ⑫ EXISTING DRINKING FOUNTAIN TO BE REMOVED. EXISTING PIPING TO BE REUSED FOR NEW FIXTURE.

FIRST FLOOR DEMOLITION PLAN
 SCALE: 1/4" = 1'-0"

Swygert & Associates
 CONSULTING ENGINEERS
DBA Swygert & Assoc., Ltd. Telephone: (803) 791-9300
 Post Office Box 11866 Columbia, SC 29211 Fax: (803) 791-0830
 email: swygert@swygert-associates.com

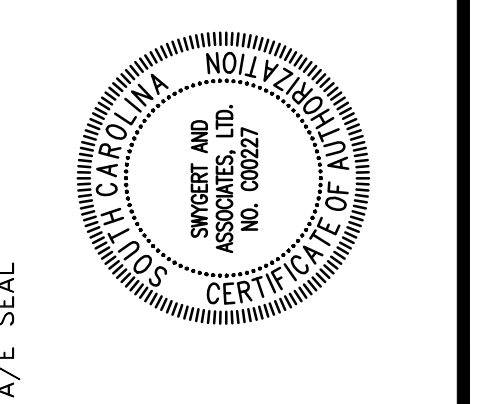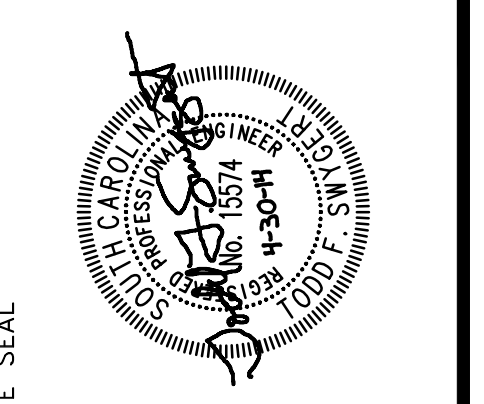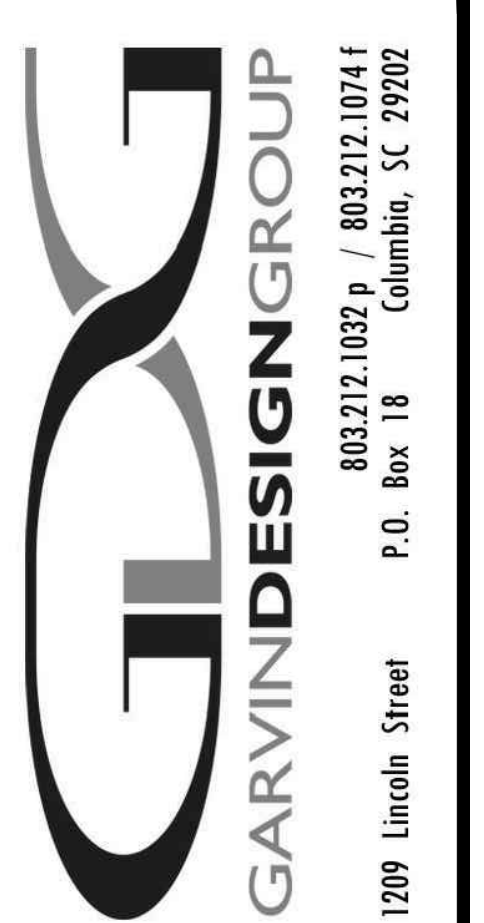

PROJECT TITLE
SWIM TEAM LOCKER ROOM RENOVATIONS
 University of South Carolina
 Solomon Blatt Physical Education Center
 1300 Wheat Street
 Columbia, SC 29208 USC
 Project No. H27-Z-158

REVISIONS	DATE
NO.	NAME

THIS DRAWING IS THE PROPERTY OF SWYBERT & ASSOCIATES, INC. IT IS TO BE USED ONLY FOR THE PROJECT AND LOCATION SPECIFICALLY IDENTIFIED HEREON. IT IS NOT TO BE REPRODUCED, COPIED, OR TRANSMITTED IN ANY FORM OR BY ANY MEANS, ELECTRONIC OR MECHANICAL, INCLUDING PHOTOCOPYING, RECORDING, OR BY ANY INFORMATION STORAGE AND RETRIEVAL SYSTEM, WITHOUT THE WRITTEN PERMISSION OF SWYBERT & ASSOCIATES, INC. © 2005 SWYBERT & ASSOCIATES, INC.


DRAWING TITLE
FIRST FLOOR DEMOLITION PLAN

DRAWING NO.
PD1.1


NOTES TO SHEET

- 1 RECONNECT NEW FIXTURE, FLUSH VALVE, ETC. TO EXISTING PIPING. PROVIDE NEW CARRIER.
- 2 RECONNECT NEW FIXTURE TO EXISTING PIPING. PROVIDE ALL NEW SUPPLIES AND TRAPS PER PLUMBING FIXTURE SCHEDULE.
- 3 APPROXIMATE LOCATION OF EXISTING 5" SANITARY WASTE LINE IN CRAWL SPACE.
- 4 APPROXIMATE LOCATION OF EXISTING SANITARY VENT LINE.
- 5 EXISTING 2" VENT LINE TO BE RAISED UP 12" TO BE LEVEL WITH REMAINING LINES.
- 6 EXISTING FLOOR DRAIN REINSTALLED IN NEW FLOOR.
- 7 INSTALL NEW SQUARE TOP STRAINER ON EXISTING FLOOR DRAIN.
- 8 PROVIDE MCGUIRE, OR APPROVED EQUAL, MODEL 8672 1 1/4" P-TRAP FOR CONNECTION TO SUITMATE PROVIDED BY OTHERS.

NOTE:
 ALL VENT PIPING SHALL
 BE 2" IN SIZE UNLESS
 OTHERWISE INDICATED.

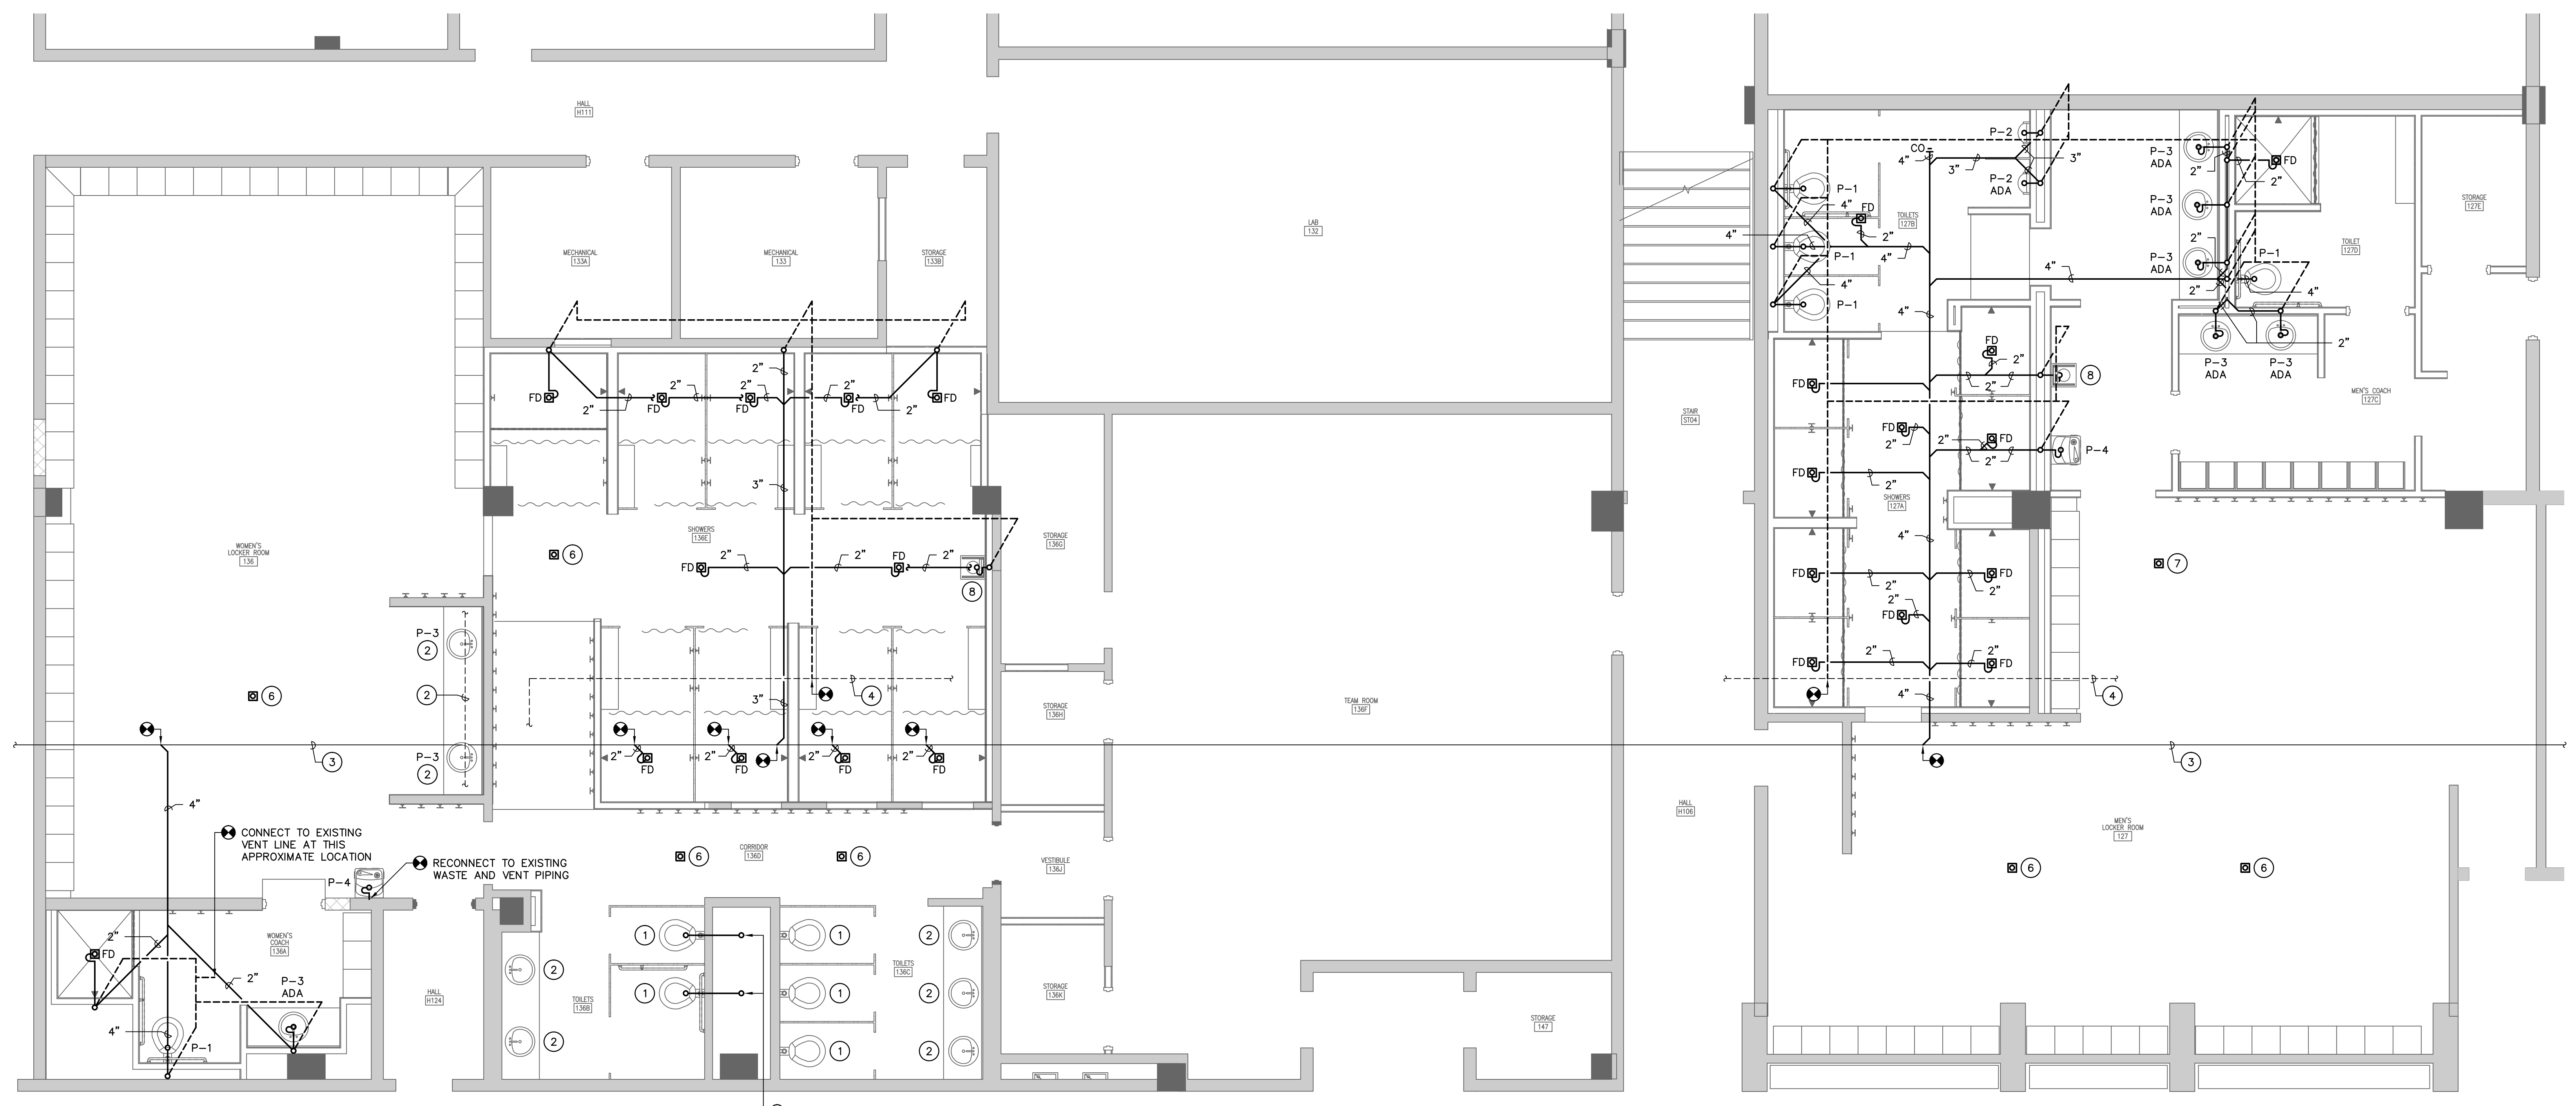

1 FIRST FLOOR PLAN
 P1.1
 SCALE: 1/4" = 1'-0"

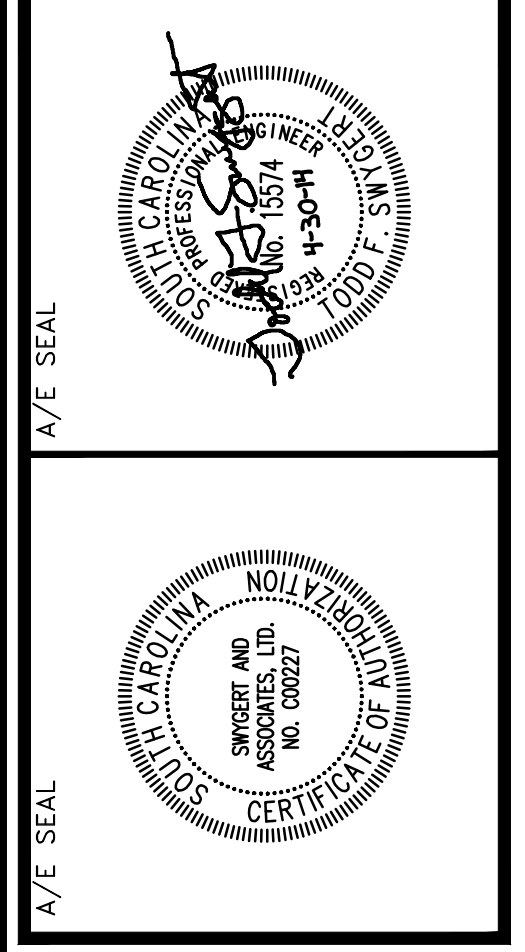

PROJECT TITLE
SWIM TEAM LOCKER ROOM RENOVATIONS
 University of South Carolina
 Solomon Blatt Physical Education Center
 1300 Wheat Street
 Columbia, SC 29208 USC
 Project No. H27-Z-158

REVISIONS	NO.	NAME	DATE

DRAWN BY: DEM
 CHECKED BY: TFS
THIS DRAWING IS THE PROPERTY OF SWYGART & ASSOCIATES, INC. IT IS TO BE USED ONLY FOR THE PROJECT AND LOCATION SPECIFICALLY IDENTIFIED HEREON. ANY REUSE OR MODIFICATION OF THIS DRAWING WITHOUT THE WRITTEN CONSENT OF SWYGART & ASSOCIATES, INC. IS STRICTLY PROHIBITED. © 2009 SWYGART & ASSOCIATES, INC.

DRAWING TITLE
FIRST FLOOR PLAN - WASTE AND VENT PIPING

Swygart & Associates
 CONSULTING ENGINEERS
DBA Swygart & Assoc., Ltd. Telephone: (803) 791-9300
 Post Office Box 11686 Columbia, S.C. 29211 Fax: (803) 791-0830
 mail@swygart-associates.com

PROJECT NO. 0328.13
DATE 04.30.14
DRAWING NO. **P1.1**

N:\PROJECTS\3255 DRAWINGS\PLUM\3255-P3-1.dwg





PLUMBING FIXTURE SCHEDULE									
P. NO.	FIXTURE	MFR.	NAME	MFRS. NO.	SIZE	MIN. SUPPLY		REMARKS	
						CW	HW		
P-1	WATER CLOSET	KOHLER	KINGSTON	K-4325	---	1"	--	WITH SLOAN MODEL 111-XL-1.28 FLUSH VALVE, BENEKE 527 SEAT, CHAIR CARRIER, AND BOLT CAPS.	
P-2	URINAL	KOHLER	DEXTER	K-5016-ET	---	3/4"	--	WITH SLOAN MODEL 186-0.5-XL FLUSH VALVE, AND CHAIR CARRIER.	
P-3	LAVATORY	KOHLER	FARMINGTON	K-2905-4	19 1/4"x16 1/4"	3/8"	3/8"	WITH DELTA MODEL 501-WHDFD FAUCET, McGUIRE 155A GRID DRAIN, McGUIRE H165 3/8" CAST BRASS SUPPLIES WITH STOPS, AND McGUIRE B872 1-1/4" P-TRAP.	
P-4	ELECTRIC WATER COOLER	OASIS	---	P8AC	---	---	---	WITH STAINLESS STEEL FINISH, McGUIRE H165 3/8" CAST BRASS SUPPLY WITH STOP, AND McGUIRE B872 1-1/4" P-TRAP, MOUNT PER ADA REQUIREMENTS.	
P-5A	SHOWER TRIM	SYMMONS	TEMPROL	C-96-1-295-X	---	1/2"	1/2"	WITH FIXED SHOWER HEAD AND INTEGRAL STOPS.	
P-5B	SHOWER TRIM	SYMMONS	TEMPROL	C-96-1-295-X-REV	---	1/2"	1/2"	WITH FIXED SHOWER HEAD, INTEGRAL STOPS, AND REVERSE CORING.	
P-5C	ACCESSIBLE SHOWER TRIM	SYMMONS	TEMPROL	25-500-B30-V-X-REV	---	1/2"	1/2"	WITH FIXED SHOWER HEAD, HAND HELD SHOWER, AND INTEGRAL STOPS.	
P-5D	ACCESSIBLE SHOWER TRIM	SYMMONS	TEMPROL	25-500-B30-V-X-REV	---	1/2"	1/2"	WITH FIXED SHOWER HEAD, HAND HELD SHOWER, INTEGRAL STOPS, AND REVERSE CORING.	
FD	FLOOR DRAIN	ZURN	---	2N-415-S	---	---	---	WITH 6"x6" NICKLE BRONZE STRAINER AND TRAP GUARD BY PROSET, OR APPROVED EQUAL.	

GENERAL NOTES

- ALL WORK SHALL BE PERFORMED ACCORDING TO ALL LOCAL, STATE, NATIONAL CODES, AND THE 2012 INTERNATIONAL PLUMBING CODE.
- DO NOT SCALE DRAWINGS. SEE ARCHITECTURAL DRAWINGS FOR EXACT DIMENSIONS, FIXTURE LOCATIONS, ETC.
- EXCEPT WHERE PIPE SPACE IS PROVIDED OR UNLESS NOTED OTHERWISE, ALL SUPPLY, WASTE AND VENT RISERS SHALL BE RUN IN WALLS AND PARTITIONS.
- COORDINATE CLOSELY WITH ALL WORK DONE UNDER OTHER DIVISIONS OF THE SPECIFICATIONS TO AVOID INTERFERENCE AND CONFLICT.
- VENTS SHALL BE COLLECTED ABOVE THE CEILING AND EXTENDED TO EXISTING VENT PIPING AS INDICATED.
- ALL VALVES WITH THREADED HOSE CONNECTIONS SHALL BE EQUIPPED WITH A WATTS REGULATOR COMPANY, NO. NFB BACK-SIPHONAGE, BACKFLOW PREVENTER.
- EXPOSED WASTE AND WATER PIPING UNDER LAVATORIES MARKED "ADA" SHALL BE INSULATED WITH HANDI LAV-GUARD KIT MODEL NUMBER 102W AS MANUFACTURED BY TRUEBRO, INC., OR APPROVED EQUAL.
- ALL PIPING INSULATION SHALL BE RUN CONTINUOUSLY.

LEGEND

SYMBOL	DESCRIPTION
	SANITARY WASTE LINE
	SANITARY VENT LINE
	DOMESTIC COLD WATER LINE
	DOMESTIC HOT WATER LINE
	SHUTOFF VALVE
	SHOCK ARRESTOR (P.D.I. RATING OF "A")
	PIPE TURNS TO, AWAY
	CLEANOUT (IN CRAWL SPACE)
	FLOOR DRAIN
ADA	FIXTURE FOR USE ACCORDING TO THE AMERICANS WITH DISABILITIES ACT
	CONNECTION POINT OF NEW TO EXISTING

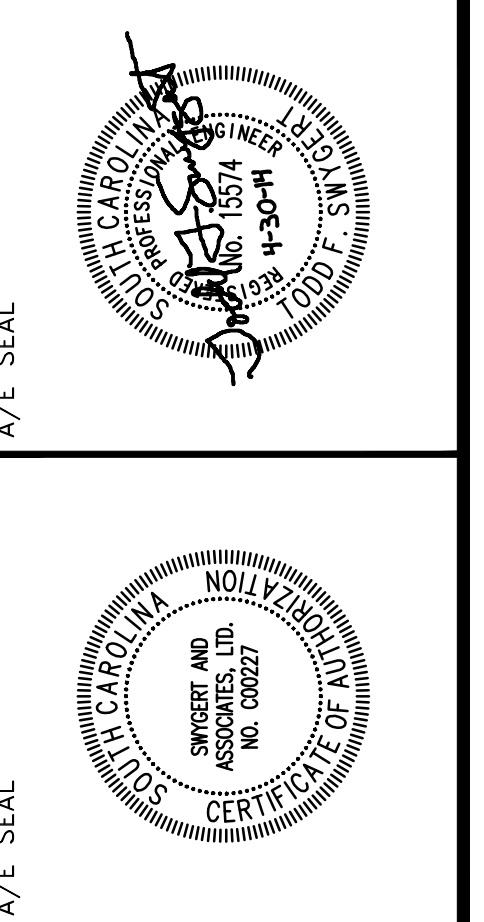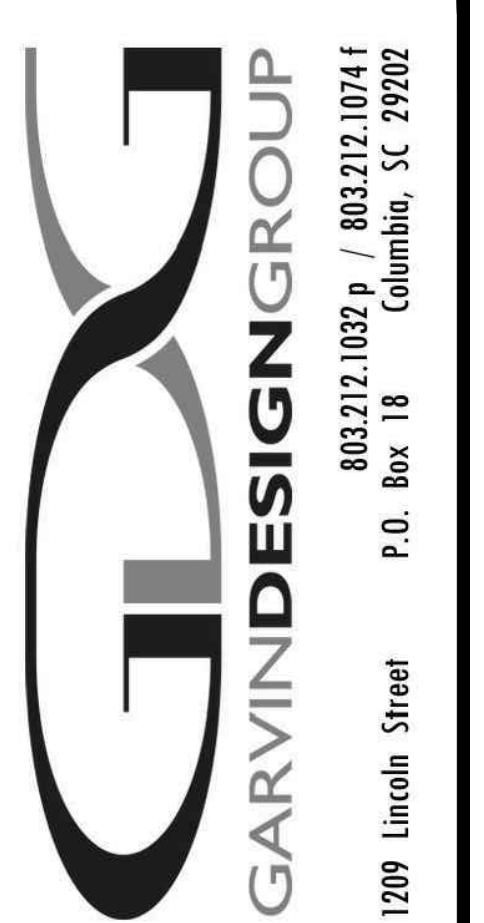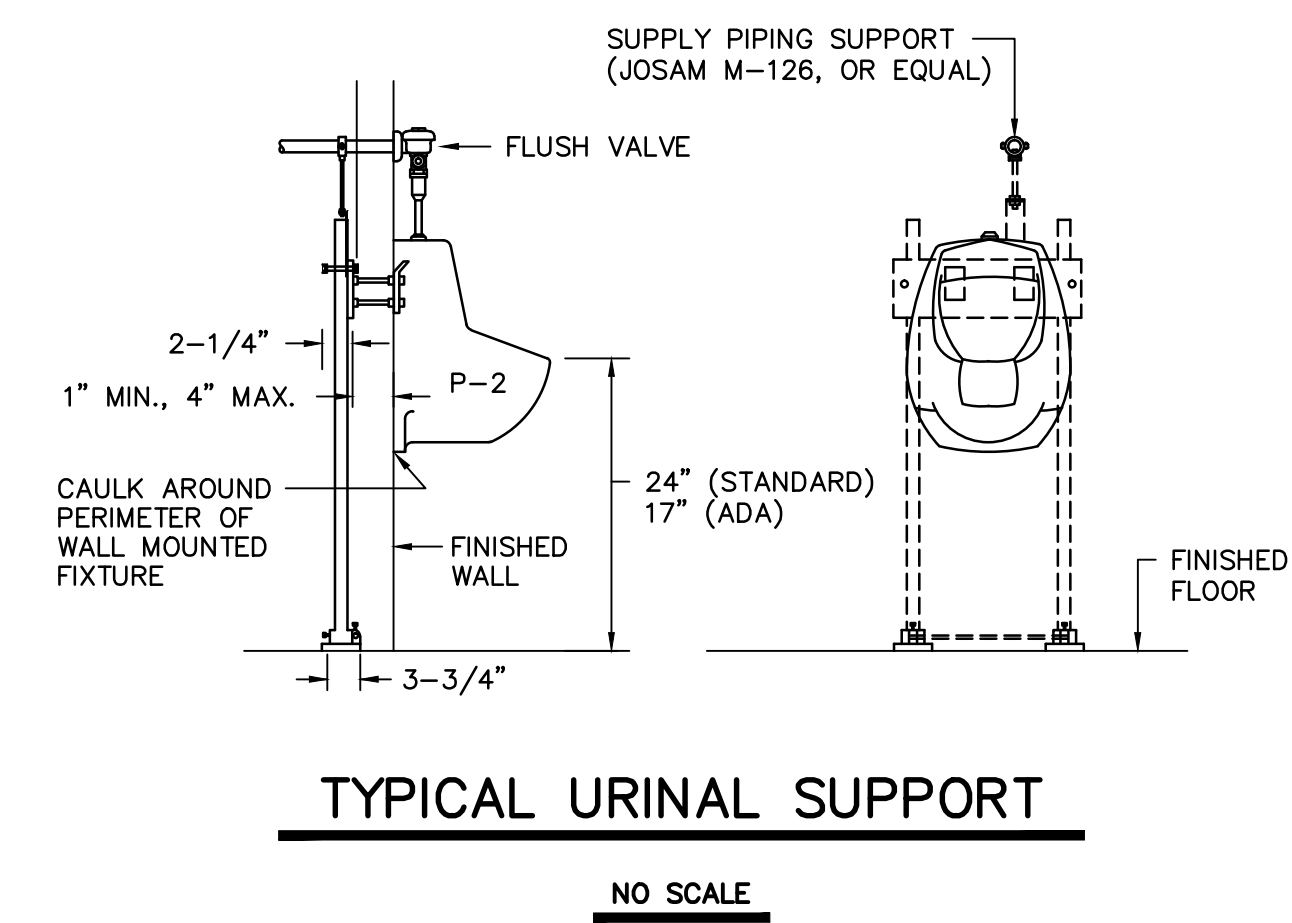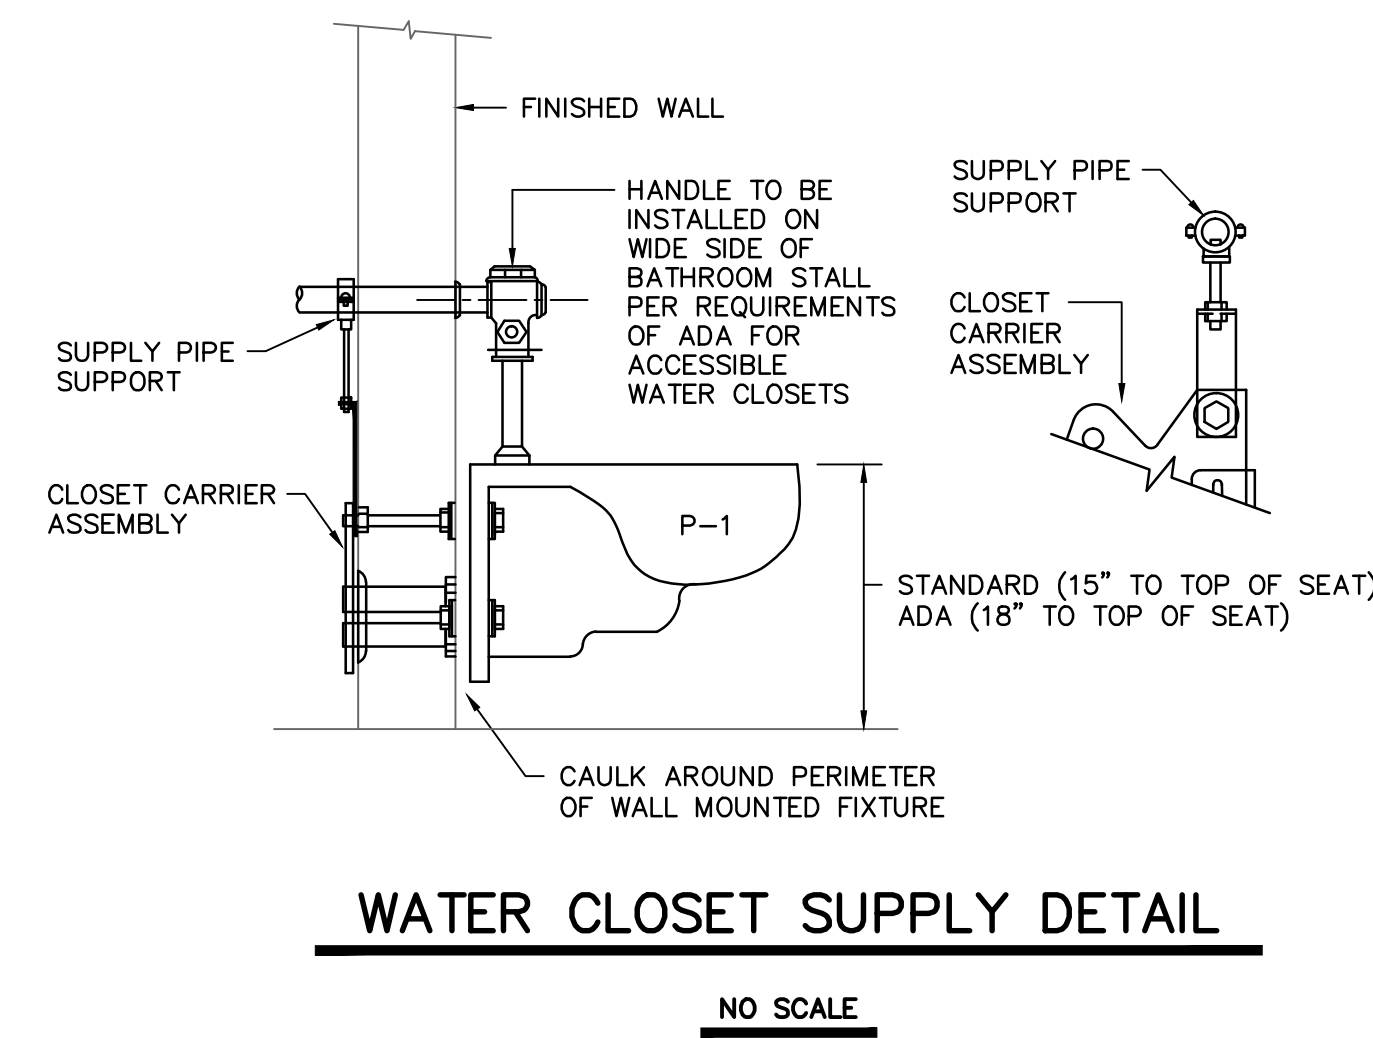

PROJECT TITLE
SWIM TEAM LOCKER ROOM RENOVATIONS
University of South Carolina
Solomon Blatt Physical Education Center
1300 Wheat Street
Columbia, SC 29208 USC
Project No. H27-Z158

REVISIONS	NO.	NAME	DATE

DRAWN BY
CHECKED BY
DEM
TFS

THIS DRAWING IS THE PROPERTY OF SWYBERT & ASSOCIATES, INC. IT IS TO BE USED ONLY FOR THE PROJECT AND LOCATION SPECIFICALLY IDENTIFIED HEREON. IT IS NOT TO BE REPRODUCED, COPIED, OR TRANSMITTED IN ANY FORM OR BY ANY MEANS, ELECTRONIC OR MECHANICAL, INCLUDING PHOTOCOPYING, RECORDING, OR BY ANY INFORMATION STORAGE AND RETRIEVAL SYSTEM, WITHOUT THE WRITTEN PERMISSION OF SWYBERT & ASSOCIATES, INC.
© 2005 SWYBERT & ASSOCIATES, INC.

DRAWING TITLE
DETAILS, NOTES, SCHEDULE, AND LEGEND

Swygert & Associates
CONSULTING ENGINEERS
DBA Swygert & Assoc., Ltd. Telephone: (803) 791-9300
Post Office Box 11686
Columbia, S.C. 29211
Fax: (803) 791-0830
mail@swygert-associates.com

PROJECT NO. 0328.13
DATE 04.30.14
DRAWING NO. **P3.1**




1 FIRST FLOOR LIGHTING DEMOLITION PLAN
 E1.1 SCALE: 1/4" = 1'-0"

- LIGHTING DEMOLITION NOTES**
- AS-BUILT DRAWINGS INDICATE THE EXISTING LIGHTING IN THE MEN'S LOCKER ROOM IS SERVED FROM BRANCH CIRCUIT H2-3. CONTRACTOR SHALL FIELD VERIFY SOURCE PRIOR TO WORK.
 - AS-BUILT DRAWINGS INDICATE THE EXISTING LIGHTING IN THE RACQUETBALL COURT IS SERVED FROM BRANCH CIRCUIT H2-15. CONTRACTOR SHALL FIELD VERIFY SOURCE PRIOR TO WORK. DISCONNECT EXISTING LIGHTING FIXTURES AND REMOVE ASSOCIATED LAMPS. ABANDON FIXTURES IN PLACE. DISCONNECT AND REMOVE ALL ASSOCIATED LIGHT SWITCHES. PROVIDE BLANK COVER PLATES WHERE SWITCHES ARE REMOVED.
 - AS-BUILT DRAWINGS INDICATE THE EXISTING LIGHTING IN THE WOMEN'S LOCKER ROOM AND TEAM ROOM IS SERVED FROM BRANCH CIRCUIT H2-4. CONTRACTOR SHALL FIELD VERIFY SOURCE PRIOR TO WORK.

HATCHED AREA REPRESENTS SPACES THAT ARE NOT INSIDE THE SCOPE OF WORK

BEA BELKA ENGINEERING ASSOCIATES, INC.
 7 CLUSTERS COURT, SUITE 201
 COLUMBIA, SOUTH CAROLINA 29210
 (803) 731-0650 fax (803) 731-2880
 EMAIL: JAreheart@bellsouth.net

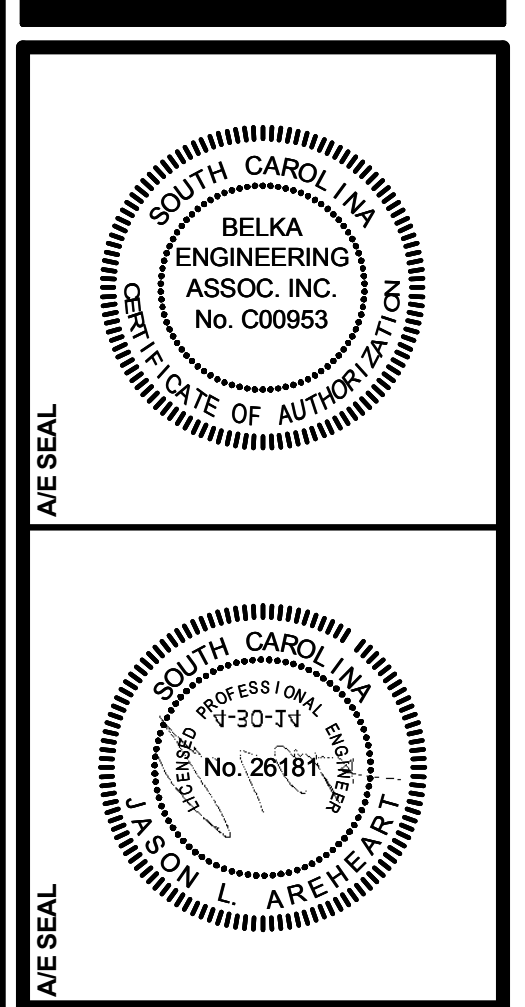



PROJECT TITLE
BLATT NATATORIUM RENOVATIONS
 University of South Carolina
 Columbia, SC 29201
 100% BID SET

NO.	REVISIONS	NAME	DATE

DRAWN BY: JJS
CHECKED BY: JJA

DRAWING TITLE
LIGHTING DEMOLITION PLAN

PROJECT NO. U0813
DATE 04.23.14
DRAWING NO.
E1.1

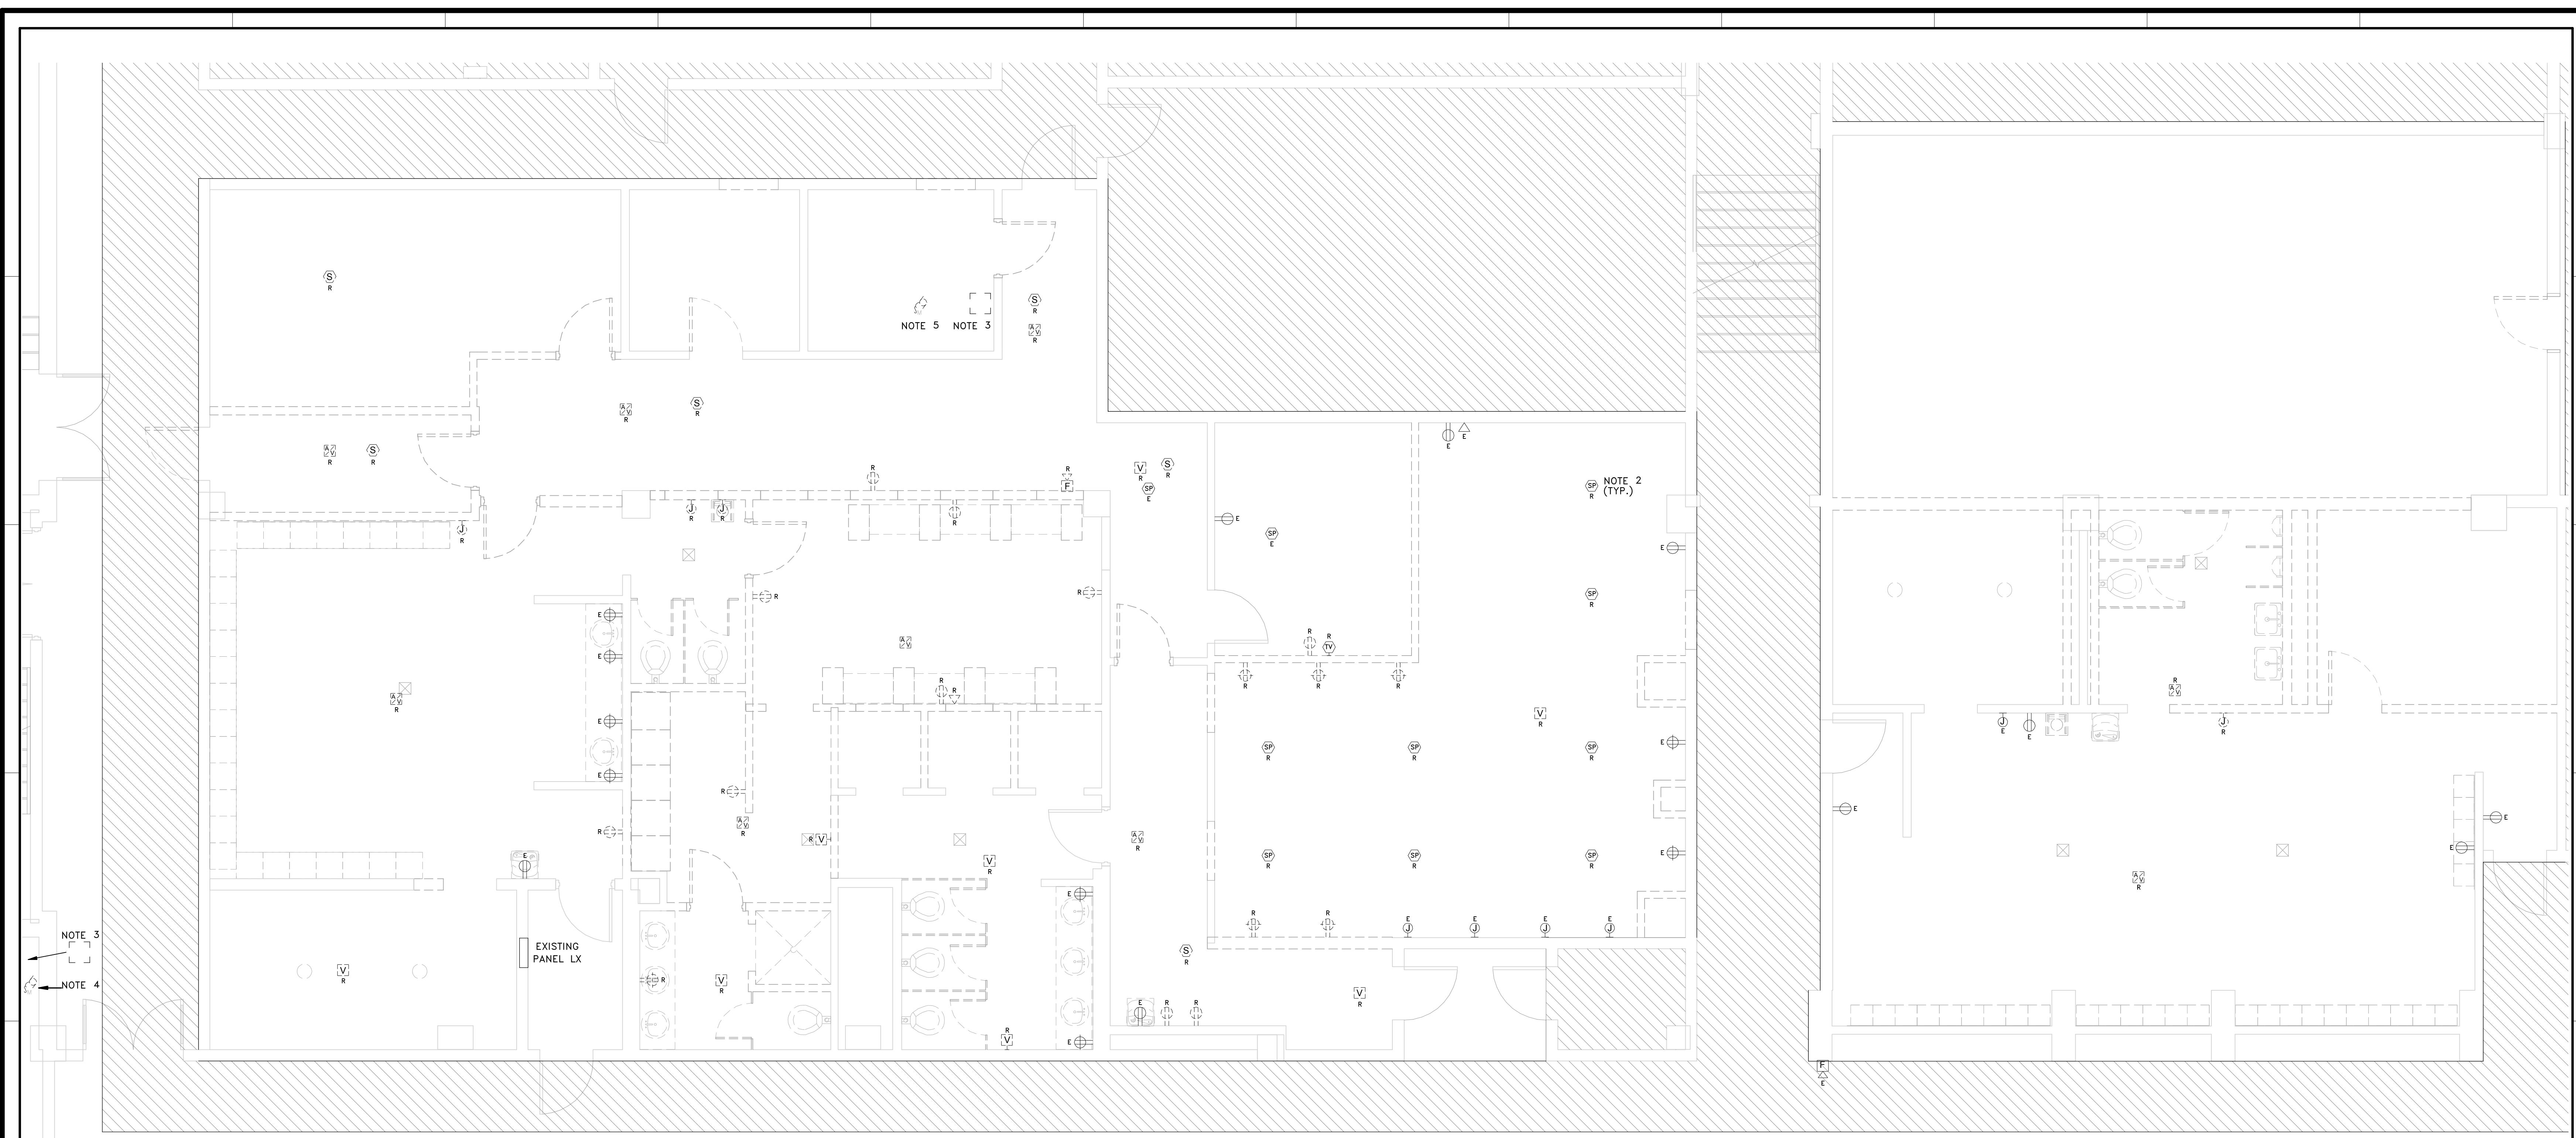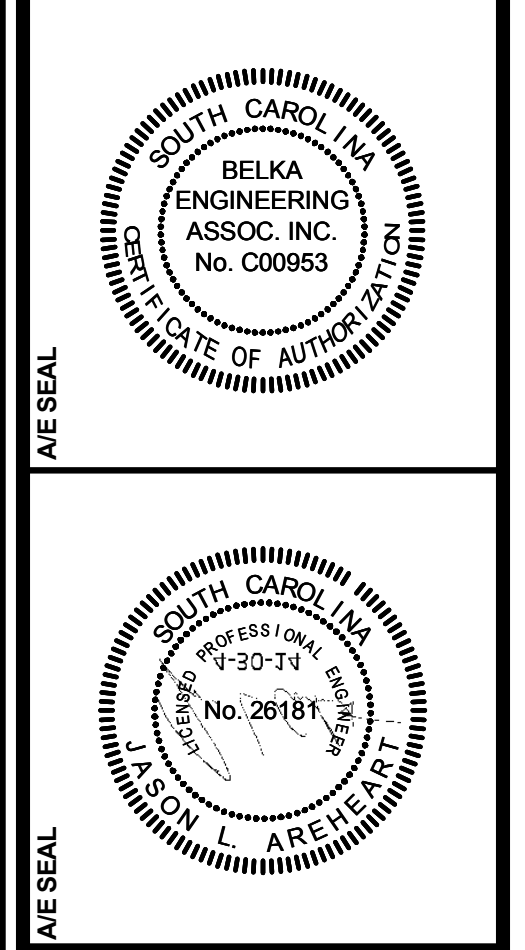

1 FIRST FLOOR POWER/SYSTEMS DEMOLITION PLAN
E1.2 SCALE: 1/4" = 1'-0"

- POWER/SYSTEMS DEMOLITION NOTES**
- FIELD VERIFY SOURCE OF ALL BRANCH CIRCUITS PRIOR TO WORK.
 - SPEAKERS DESIGNATED FOR REMOVAL SHALL BE TURNED OVER TO OWNER.
 - ELECTRICAL CONTRACTOR SHALL DISCONNECT FEEDERS FOR THIS SPLIT SYSTEM. DEMOLISH BRANCH CIRCUITS IN THEIR ENTIRETY. LABEL BREAKER IN PANEL H9 AS SPARE. BREAKER IN PANEL L9 SHALL BE REPLACED IN RENOVATION PHASE.
 - ELECTRICAL CONTRACTOR SHALL DISCONNECT FEEDER FOR THIS EXHAUST FAN. MAINTAIN CONTINUITY OF REMAINING BRANCH CIRCUIT.
 - ELECTRICAL CONTRACTOR SHALL DISCONNECT FEEDER FOR CP-1. CIRCUIT SHALL BE EXTENDED IN RENOVATION PHASE TO FEED NEW EXHAUST FAN.

EXISTING

Branch Panel: LX

Location: HALL H124
Supply From: EXISTING PANEL "L2"
Mounting: Recessed
Enclosure: Type 1

Volts: 120/208 Single
Phases: 1
Wires: 3

A.I.C. Rating: 10,000
Mains Type: MCB
Mains Rating: 60 A
MCB Rating: 60 A

Notes:

CKT	Circuit Description	Wire ID	Trip	Poles	A	B	Poles	Trip	Wire ID	Circuit Description	CKT
1	SUITEMATE - WOMENS		0 A	1	0.0 kVA	0.0 kVA	1	0 A		HAIR / HAND DRYER	2
3	SUITEMATE - MENS		0 A	1	0.0 kVA	0.0 kVA	1	0 A		VANITY LIGHTING	4
5	WATER FOUNTAIN		0 A	1	0.0 kVA	0.0 kVA	1	0 A		VANITY RECPS.	6
7	EXHAUST FAN		0 A	1	0.0 kVA	0.0 kVA	1	0 A		VANITY RECPS.	8
9	MAIN CIRCUIT BREAKER		0 A	2	0.0 kVA	0.0 kVA	1	0 A		Spare	10
11					0.0 kVA	0.0 kVA	1	0 A		Spare	12
					Total Load:	0.0 kVA	0.0 kVA				
					Total Amps:	0 A	0 A				

Legend:

Panel Totals
Total Conn. Load: 0 VA

BEA BELKA ENGINEERING ASSOCIATES, INC.

7 CLUSTERS COURT, SUITE 201
COLUMBIA, SOUTH CAROLINA 29210
(803) 731-0650 fax (803) 731-2880
EMAIL: jAreheart@bellsouth.net


GA21404

PROJECT NO.	DATE	DRAWING NO.
LOE1.13	04.23.14	E1.2

DRAWN BY:	CHECKED BY:
JLS	JLA

REVISIONS	NO.	NAME	DATE

PROJECT TITLE
POWER/SYSTEMS DEMOLITION PLAN

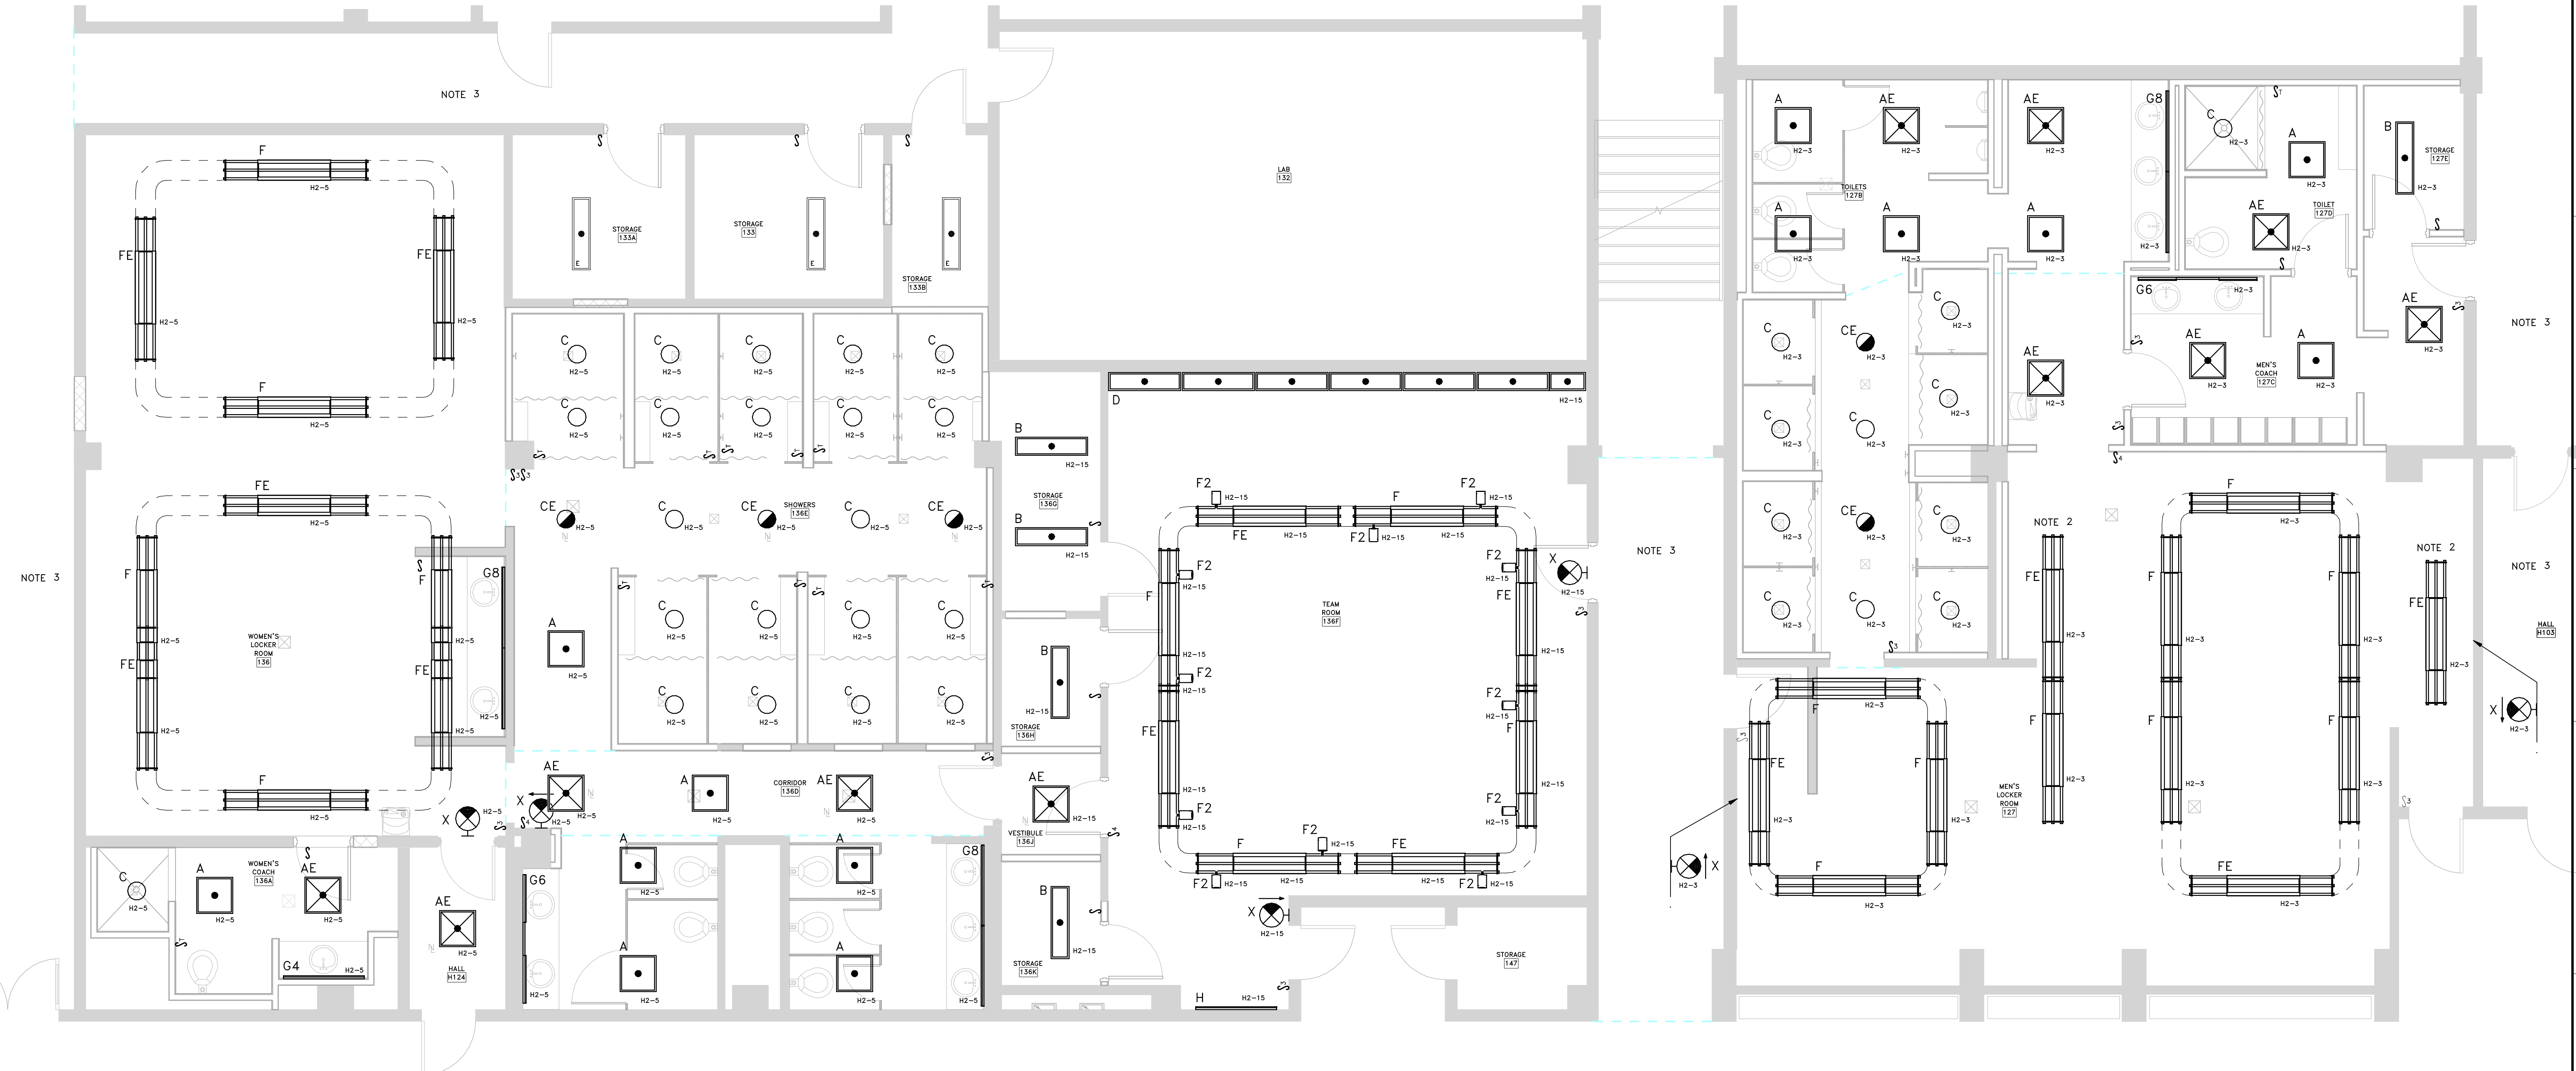


1 FIRST FLOOR LIGHTING RENOVATION PLAN
 E2.1 SCALE: 1/4" = 1'-0"

- LIGHTING RENOVATION NOTES**
- INTENT IS FOR EXISTING LIGHTING BRANCH CIRCUIT IN EACH SPACE TO BE USED FOR NEW LIGHTING SYSTEMS. FIELD VERIFY SOURCE OF EACH BRANCH CIRCUIT PRIOR TO WORK.
 - INVERT TYPE "F" FIXTURES REFERENCED TO THIS NOTE SUCH THAT FIXTURES' LENS ARE DOWN. ALL OTHER TYPE "F" FIXTURES SHALL BE ORIENTED FOR INDIRECT TYPE LIGHTING.
 - CEILING IN THIS AREA SHALL BE REMOVED TO ACCOMMODATE DIVISION 23 WORK. PROTECT ALL EXISTING LIGHTING FIXTURES, FIRE ALARM DEVICES, AND ANY OTHER ELECTRICAL SYSTEMS FROM DAMAGE DURING WORK. TEMPORARILY DISCONNECT AND REMOVE EXISTING LIGHTING FIXTURES AND OTHER CEILING MOUNTED EQUIPMENT DURING MECHANICAL WORK AND RE-INSTALL ONCE DUCT WORK IS COMPLETE.

BEA BELKA ENGINEERING ASSOCIATES, INC.
 7 CLUSTERS COURT, SUITE 201
 COLUMBIA, SOUTH CAROLINA 29210
 (803) 731-0650 fax (803) 731-2880
 EMAIL: jAreheart@bellsouth.net

GARVINDESIGNGROUP
 architecture interiors planning
 1209 Lincoln Street P. O. Box 18 Columbia, SC 29202
 803.212.1074 p / 803.212.1074 f

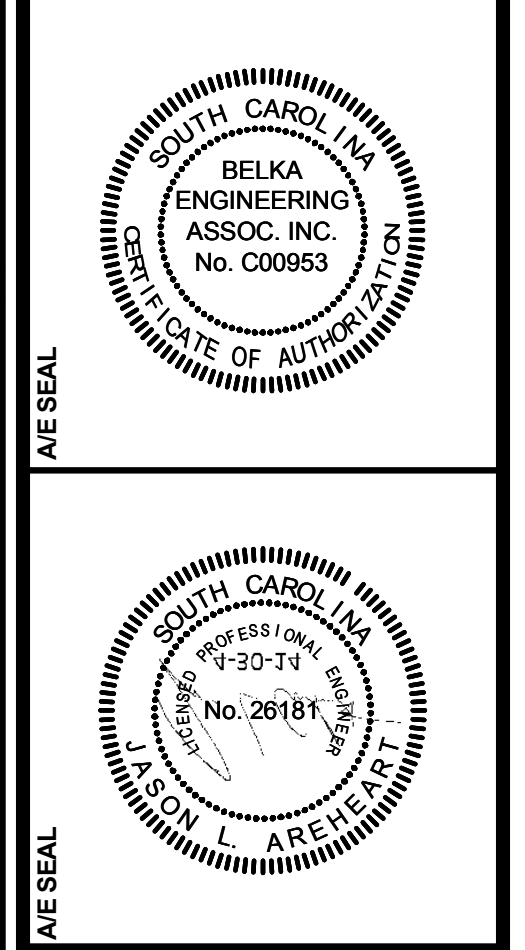


BLATT NATATORIUM RENOVATIONS
 PROJECT TITLE
 University of South Carolina
 Columbia, SC 29201
 100% BID SET

NO.	REVISIONS	NAME	DATE

DRAWN BY:	JJS
CHECKED BY:	JLA

LIGHTING RENOVATION PLAN
 DRAWING TITLE
 PROJECT NO. 04.23.14
 DATE 04.23.14
 DRAWING NO. **E2.1**

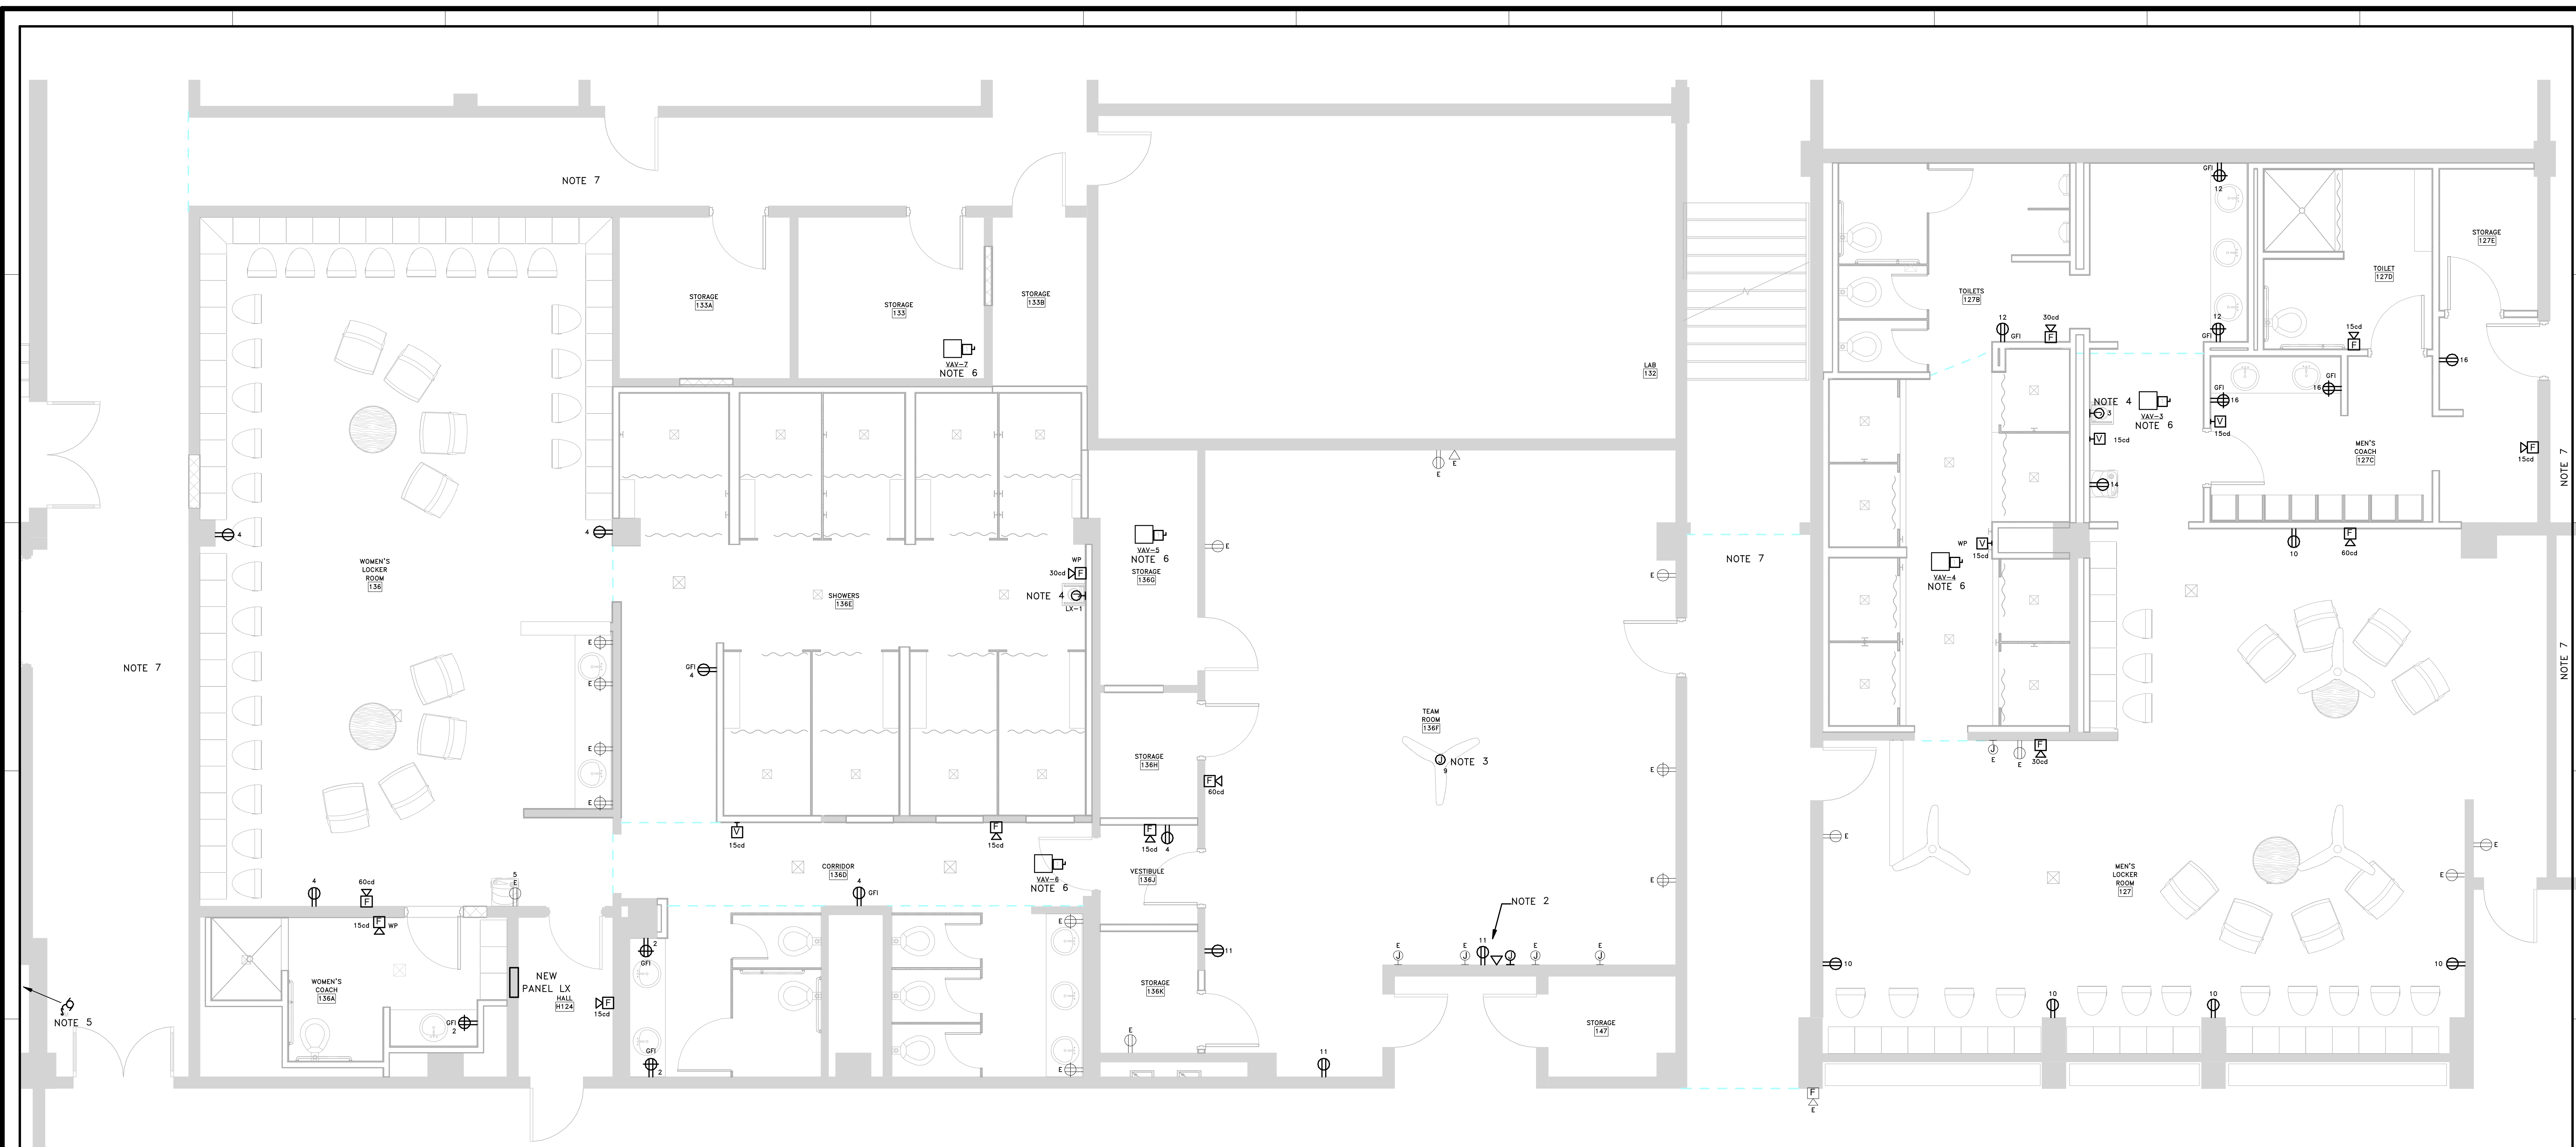

1 FIRST FLOOR POWER/SYSTEMS RENOVATION PLAN
 E2.2 SCALE: 1/4" = 1'-0"

- POWER/SYSTEMS RENOVATION NOTES**
- ALL ELECTRICAL EQUIPMENT AND DEVICES ON THIS SHEET SHALL BE FED FROM PANEL "LX" WITH CIRCUIT NUMBERS AS INDICATED.
 - PROVIDE DUPLEX RECEPTACLE, DATA JUNCTION BOX, AND A/V JUNCTION BOX SURFACE MOUNTED ON WALL CONCEALED BY TV. COORDINATE EXACT LOCATION WITH ARCHITECT PRIOR TO ROUGH-IN.
 - PROVIDE ELECTRICAL CONNECTION TO CEILING FAN (FURNISHED AND INSTALLED BY DIVISION 23). PROVIDE CONTROL WIRING AND MAKE ALL REQUIRED CONNECTIONS.
 - PROVIDE HARDWIRED CONNECTION TO EXISTING RELOCATED SUITMATE EQUIPMENT PER MANUFACTURER'S INSTRUCTIONS.
 - EXTEND CIRCUIT THAT PREVIOUSLY FED CP-1 TO NEW EXHAUST FAN LOCATION.
 - CONTRACTOR SHALL PROVIDE TWO 20 AMP SINGLE POLE BREAKERS IN THE PLACE OF THE 20 AMP TWO POLE BREAKER WHICH PREVIOUSLY FED AH-1. LABEL ONE BREAKER AS A SPARE. THE OTHER BREAKER SHALL FEED NEW VAVS.
 - CEILING IN THIS AREA SHALL BE REMOVED TO ACCOMMODATE DIVISION 23 WORK. PROTECT ALL EXISTING LIGHTING FIXTURES, FIRE ALARM DEVICES, AND ANY OTHER ELECTRICAL SYSTEMS FROM DAMAGE DURING WORK. TEMPORARILY DISCONNECT AND REMOVE EXISTING LIGHTING FIXTURES AND OTHER CEILING MOUNTED EQUIPMENT DURING MECHANICAL WORK AND RE-INSTALL ONCE DUCT WORK IS COMPLETE.

NEW

Branch Panel: LX
 Location: HALL H124
 Supply From: EXISTING PANEL "L2"
 Mounting: Recessed
 Enclosure: Type 1

Volts: 120/208 Single
 Phases: 1
 Wires: 3

A.I.C. Rating: 10,000
 Mains Type: MCB
 Mains Rating: 60 A
 MCB Rating: 60 A

Notes:
 - CIRCUIT NUMBER(S) 14 SHALL BE GFCI BREAKER TYPE.

CKT	Circuit Description	Wire ID	Tripp	Poles	A	B	Poles	Tripp	Wire ID	Circuit Description	CKT	
1	SUITMATE - WOMENS		20 A	1	1.4 kVA	0.6 kVA			20 A	RECPS - WOMENS	2	
3	SUITMATE - MENS		20 A	1			1.4 kVA	1.2 kVA	20 A	RECPS - WOMENS	4	
5	WATER FOUNTAIN		20 A	1	0.2 kVA	0.4 kVA			20 A	VANITY RECPS - WOMENS	6	
7	EXHAUST FAN		20 A	1		0.0 kVA	0.4 kVA		20 A	VANITY RECPS - WOMENS	8	
9	CEILING FAN		20 A	1	1.0 kVA	1.0 kVA			20 A	RECPS - MENS	10	
11	RECPS / TV		20 A	1		0.6 kVA	0.6 kVA		20 A	VANITY RECPS - MENS	12	
13	Spare		20 A	1	0.0 kVA	0.2 kVA			20 A	EW-C. GFI BREAKER *	14	
15	Spare		20 A	1		0.0 kVA	0.6 kVA		20 A	VANITY RECPS - MENS COACH	16	
17	Spare		20 A	1	0.0 kVA	0.0 kVA			20 A	Spare	18	
					Total Load:	4.8 kVA	4.8 kVA					
					Total Amps:	46 A	46 A					

Legend:

Panel Totals
 Total Conn. Load: 9600 VA

GA21404

BEA BELKA ENGINEERING ASSOCIATES, INC.

7 CLUSTERS COURT, SUITE 201
 COLUMBIA, SOUTH CAROLINA 29210
 (803) 731-0650 fax (803) 731-2880
 EMAIL: JAreheart@bellsouth.net

GARVINDESIGNGROUP
 architecture interiors planning
 1209 Lincoln Street P. O. Box 18 Columbia, SC 29202
 803.212.1032 p / 803.212.1074 f

BELKA ENGINEERING ASSOC. INC.
 No. C00953
 STATE OF SOUTH CAROLINA
 PROFESSIONAL ENGINEER

BELKA ENGINEERING ASSOC. INC.
 No. 2618
 STATE OF SOUTH CAROLINA
 PROFESSIONAL ENGINEER

PROJECT TITLE
BLATT NATATORIUM RENOVATIONS
 University of South Carolina
 Columbia, SC 29201
 100% BID SET

REVISIONS

NO.	DATE	NAME

DRAWN BY: JJA
CHECKED BY: JJA

DRAWING TITLE
POWER/SYSTEMS RENOVATION PLAN

PROJECT NO. UOR13
DATE 04.23.14
DRAWING NO. E2.2